GENERAL NOTES

- 1. ALL WORK SHALL CONFORM TO THE RULES AND REGULATIONS. CODES AND ORDINANCES OF FEDERAL, STATE AND LOCAL GOVERNMENTAL AGENCIES HAVING JURISDICTION OVER THE PROJECT, NO WORK SHOWN SPECIFIED OR IMPLIED SHALL BE
- CONSTRUCTED TO CONFLICT WITH ANY GOVERNMENT AGENCY OR BUILDING AUTHORITY MANDATE. 12. NO WORK SHALL BEGIN UNTIL A BUILDING PERMIT HAS BEEN ISSUED.
- 3. GENERAL CONTRACTOR SHALL PROVIDE GENERAL LIABILITY INSURANCE, WORKMEN COMPENSATION INSURANCE AND DISABILITY INSURANCE BEFORE PERFORMING ANY WORK IN THIS BUILDING.
- 4. THE CONTRACTOR SHALL INSPECT THE SITE AND CHECK AND VERIFY EXISTING AND PROPOSED CONDITIONS BEFORE STARTING ANY WORK. THE CONTRACTOR SHALL BRING THE DISCREPANCIES TO THE ARCHITECT'S OR ENGINEER'S ATTENTION BY WRITING PRIOR TO SUBMIT ANY QUOTES OR ESTIMATES PRIOR TO COMMENCING WORK. 5. ALL NEW WORK CONFORMS TO THE NEW YORK STATE ENERGY CODE.
- 6. ALL FEES, PERMITS APPLICATIONS, INSPECTIONS, CERTIFICATES AND SIGN-OFF SHALL BE SECURED BY THE CONTRACTOR AND PAID FOR BY THE OWNER UNLESS OTHERWISE NOTED. 7. ALL NOTES HEREIN MENTIONED ALONG WITH THOSE ON THE VARIOUS DRAWINGS SHALL APPLY TO ALL DRAWINGS AND IS
- PART OF THE CONTRACT. 8, THE CONTRACTOR SHALL PROVIDE ALL THE LABOR AND MATERIAL NECESSARY FOR THE COMPLETION OF THE WORK AS
- SHOWN ON THE DRAWINGS. 9. THE CONTRACTOR SHALL CARRY OUT ALL THE WORK IN A FIRST CLASS WORKMAN-LIKE MANNER. HE SHALL MAINTAIN A SAFE. CLEAN JOB SITE AT ALL TIMES, FREE FROM DEBRIS ACCUMULATION, AND SHALL LEAVE THE JOB SITE BROOM
- CLEAN AT THE COMPLETION OF THE PROJECT. 10. THE CONTRACTOR SHALL BE SOLELY RESPONSIBLE FOR ANY AND ALL DAMAGE TO NEW OR EXISTING CONDITIONS
- CAUSED BY HIMSELF, HIS WORKMEN OR HIS SUBCONTRACTOR. HE SHALL REPAIR SUCH DAMAGE AT NO ADDITIONAL COST
- TO THE OWNER UNLESS OTHERWISE NOTED IN WRITING PRIOR TO STARTING WORK. 11. ALL MATERIALS AND CONSTRUCTION TO BE INCORPORATED IN THE WORK SHALL BE IN STRICT ACCORDANCE WITH THE LATEST EDITION OF THE ASTM SPECIFICATIONS APPLICABLE AND TO CONFORM TO THE STANDARDS AND RECOMMENDATIONS OF THE VARIOUS TRADE INSTITUTES (ACI, AISC, ETC.) WHERE APPLICABLE. ALL MATERIALS
- 12. INCORPORATED INTO THE WORK SHALL BE NEW. FREE FROM DEFECTS UNLESS OTHERWISE NOTED. 13. CONTRACTORS SHALL BE RESPONSIBLE FOR ADEQUATELY BRACING AND PROTECTING ALL WORK DURING CONSTRUCTION AGAINST DAMAGE, BREAKAGE, COLLAPSE, DISTORTIONS, STANDARDS AND GOOD PRACTICE. CONTRACTOR AGREES THAT HE SHALL ASSUME SOLE AND COMPLETE RESPONSIBILITY FOR THE SITE CONDITIONS DURING THE COURSE OF CONSTRUCTION OF THIS PROPERTY, THAT REQUIREMENT SHALL APPLY CONTINUOUSLY AND NOT BE LIMITED TO NORMAL WORKING HOUR THE CONTRACTOR SHALL DEFEND, INDEMNIFY & HOLD THE ARCHITECT OR ENGINEER HARMLESS FROM ANY ALL LIABILITY,
- REAL OR ALLEGED IN CONNECTION WITH THE PERFORMANCE OF WORK ON THIS PROJECT. 14. THE ARCHITECT OR ENGINEER OF DESIGN HAS NOT BEEN RETAINED FOR ANY FILED SUPERVISION OR INSPECTION. HIS RESPONSIBILITY IS LIMITED TO THE ACCURACY OF THE PLANS.
- 15. MATERIALS NOT SPECIFIED SUCH AS MAKE, STYLE, COLORS ETC. SHALL BE APPROVED BY THE OWNER PRIOR TO PURCHASING AND INSTALLATION BY CONTRACTORS.
- 16. THIS PLAN IS APPROVED ONLY FOR WORK INDICATED ON THE APPLICATION SPECIFICATION SHEET. ALL OTHER MATTERS SHOWN ARE NOT TO BE RELIED UPON, OR TO BE CONSIDERED AS EITHER-BEING APPROVED OR IN ACCORDANCE WITH APPLICABLE CODES.

BUILDING DEPARTMENT NOTES:

- 1. ALL CONSTRUCTION SHALL CONFORM TO THE REQUIREMENTS OF THE NEW YORK CITY
- ADMINISTRATIVE BUILDING CODE EFFECTIVE 2014 AND AMENDMENTS THERETO. 2. GENERAL CONTRACTOR SHALL OBTAIN GENERAL LIABILITY INSURANCE, WORKMEN'S
- COMPENSATION INSURANCE AND DISABILITY INSURANCE BEFORE PERFORMING ANY WORK. 3. ALL NEW WORK SHALL CONFORM TO THE NEW YORK CITY ENERGY CONSERVATION CODE.
- 4. ALL FEES, PERMITS, APPLICATIONS, INSPECTIONS CERTIFICATION, SIGN-OFFS SHALL BE SECURED AND PAID FOR BY THE CONTRACTOR.
- 5. THE GENERAL CONTRACTOR SHALL PROVIDE ALL THE LABOR AND MATERIAL FOR THE
- COMPLETION OF THE WORK AS SHOWN ON THE DRAWINGS AND SPECIFICATIONS. 6. SAFETY OF PUBLIC AND PROPERTY DURING CONSTRUCTION OPERATIONS SHALL BE IN
- ACCORDANCE WITH ARTICLE 1B. 7. THE WORK SHOWN ON THE DRAWINGS DO NOT CHANGE USE, OCCUPANCY, AND EGRESS.

DEMOLITION NOTES

- 1. CONTRACTOR SHALL TAKE ALL NECESSARY PRECAUTIONS TO PROTECT OWNER'S PROPERTY AND PERSONNEL DURING THE DEMOLITION OPERATION.
- 2. GENERAL CONTRACTOR SHALL BE RESPONSIBLE FOR MEANS AND METHOD FOR SUPPORTING EXISTING STRUCTURE DURING REMOVAL OF BEARING WALL AS SHOWN ON DRAWINGS OR ANY OTHER DEMOLITION ELSEWHERE ON THE PROJECT RELATED CONSTRUCTION. ADEQUATE SHORING DESIGNED BY A NEW YORK STATE-REGISTERED PROFESSIONAL ENGINEER RETAINED BY THE CONTRACTOR SHALL BE PROPERLY INSTALLED PRIOR TO THE START OF DEMOLITION.
- 3. ALL DEMOLITION WORK SHALL CONFORM TO OSHA REQUIREMENTS, WHICH WILL INCLUDE INSTALLATION OF WARNING SIGNS, STAGING REFLECTOR AND OR VISIBILITY AIDS. 4. ALL DEBRIS SHALL BE REMOVED FOR OFF-SITE DISPOSAL IN COMPLIANCE WITH LOCAL, STATE AND FEDERAL LAWS.
- 5. ITEMS IDENTIFIED BY THE OWNER FOR SALVAGE SHALL BE HAULED TO STORAGE LOCATION AS PER THE OWNER'S DIRECTION. 6. DEMOLITION CONTRACTOR SHALL LEAVE THE SITE CLEAN FREE OF DEBRIS, TRUCK TRACKS ON SIDE WALKS AND
- COURT YARD SHALL BE AVOIDED. WATER USED FOR SAW-CUTTING CONCRETE SHALL BE COLLETED WITH THE AID OF WET & DRY INDUSTRIAL VACUUM TO ENSURE SITE CLEANLINESS. 7. AREA AROUND INDOOR DEMOLITION WORK SHALL BE COVERED WITH DUSTPROOF AND NOISE-PROOF PVC OR OTHER ACCEPTABLE ENCLOSURE WITH OSHA SPECIFIED INDEPENDENT VENTILATION SYSTEM.

8. ANY MASONRY WALLS, PARTITIONS, PIERS, BEAMS AND COLUMNS SHALL NOT BE DAMAGED DURING DEMOLITION

UNLESS DIRECTED BY PROJECT ENGINEER 9. DO NOT DAMAGE ANY EXISTING POWER LINES AND UTILITY LINES DURING DEMOLITION.

SCOPE OF WORK:

- 1. CONSTRUCT NEW VERTICAL EXTENSION
- REMOVE PARTITIONS CONSTRUCT NEW STAIR
- . CONSTRUCT NEW PARTITIONS
- 5. INSTALL NEW PLUMBING FIXTURES 6. INSTALL NEW GAS FIXTURES

ASBESTOS NOTE:

IN THE EVENT OF ASBESTOS OR OTHER TOXIC SUBSTANCE EXPOSURE OR THE SUBSTANTIAL RISK THEREOF, CLIENT WILL HAVE THE DUTY TO INFORM THE ENGINEER OF SUCH RISKS KNOWN OR REASONABLY KNOWABLE TO THE CLIENT. IF ASBESTOS OR ANY OTHER TOXIC SUBSTANCE, OR RISKS TO EXPOSURE THEREOF IS DISCOVERED BY THE ENGINEER DURING WORK ON THE PROJECT, THE ENGINEER SHALL, IN ITS SOLE DISCRETION, HAVE THE RIGHT TO SUSPEND WORK ON THE PROJECT. THE CLIENT SHALL HAVE THE DUTY TO PROMPTLY RETAIN A QUALIFIED EXPERT TO SAFELY RENDER OR SUPERVISE THE REMOVAL OF SUCH ASBESTOS OR OTHER TOXIC SUBSTANCE. THE CLIENT SHALL INDEMNIFY AND HOLD ENGINEER, AGENTS AND EMPLOYEES HARMLESS FROM ANY AND ALL LIABILITY ON PART OF OR DAMAGE TO SUCH ENTITIES OR PERSONS INCLUDING THE COST OF LEGAL FEES AND EXPENSES, AS SUCH FEES AND EXPENSES ARE INCURRED, WHICH MAY RESULT FROM ASBESTOS OR OTHER TOXIC SUBSTANCE EXPOSURE ON THE PROJECT.

ENERGY CODE COMPLIANCE NOTE:

TO THE BEST OF MY KNOWLEDGE, BELIEF AND PROFESSIONAL JUDGMENT, THESE PLANS AND SPECIFICATIONS IN COMPLIANCE WITH NYCECC 2016. FLOOD NOTE:

PROPERTY IS NOT IN SPECIAL FLOOD HAZARD AREA. AS PER FIRM MAP DATED 2007 AND 2013

LIST OF DRAWING:

- . T-001.00 PLOT PLAN, GENERAL NOTES T-002.00 BUILDING CODE, CONSTRUCTION NOTES 3. T-003.00 ABBREVIATIONS AND SYMBOLS
- 4. T-004.00 HANDICAPPED NOTES 5. Z-100.00 ZONING INFORMATION 6. EN-001.00 ENERGY ANALYSIS REPORT 7. D-100.00 SUB-CELLAR DEMOLITION PLAN
- 8. D-101.00 CELLAR DEMOLITION PLAN 9. D-102.00 FIRST FLOOR DEMOLITION PLAN 10. D-103.00 SECOND FLOOR DEMOLITION PLAN 11. D-104.00 THIRD FLOOR DEMOLITION PLAN
- 12. D-105.00 FOURTH FLOOR DEMOLITION PLAN 13. D-106.00 FIFTH FLOOR DEMOLITION PLAN
- 14. D-107.00 SIXTH FLOOR DEMOLITION PLAN 15. D-108.00 ROOF DEMOLITION PLAN
- 16. A-100.00 SUB-CELLAR PROPOSED PLAN 17. A-101.00 CELLAR PROPOSED PLAN
- 18. A-102.00 FIRST FLOOR PROPOSED PLAN
- 19. A-103.00 SECOND FLOOR PROPOSED PLAN 20. A-104.00 THIRD FLOOR PROPOSED PLAN
- 21. A-105,00 FOURTH FLOOR PROPOSED PLAN
- 22. A-106.00 FIFTH FLOOR PROPOSED PLAN 23. A-107.00 SIXTH FLOOR PROPOSED PLAN
- 24. A-108.00 ROOF PROPOSED PLAN 25. A-109.00 BUILKHEAD PROPOSED PLAN AND EMR PLAN/SECTION
- 26. A-200.00 ELEVATION 27. A-300.00 SECTION
- 28. A-301.00 SECTION2
- 29. A-302.00 WALL SECTION DETAIL 30. A-400.00 DETAIL

SPECIAL INSPECTION NOTES:

			1.5		•
1.	STRUCTURAL STEEL - WELDING			BC	1704.3.1
2.	STRUCTURAL STEEL - DETAILS			BC	1704.3.2
3.	STRUCTURAL STEEL — HIGH STRENGTH BOLTING		. 3 3	BC	1704.3.3
4.	STRUCTURAL COLD-FORMED STEEL			BC	1704.3.4
5.	CONCRETE - CAST-IN-PLACE			· BC	1704.4
6.	MASONRY		1.1	BC	1704.5
7.	MECHANICAL SYSTEMS			BC	1704.16
8.	STRUCTURAL STABILITY - EXISTING BUILDINGS			BC	1704.20.
9.	SPRINKLER SYSTEMS			BC	1704.23
10	. STANDPIPE SYSTEMS		1.	BC	1704.24
11	. FIRE-RESISTANT PENETRATIONS AND JOINTS	. ,		BC	1704.27
12	. PRELIMINARY			28-	-116.21,
13	. ENERGY CODE COMPLIANCE INSPECTIONS			BC	110.3.5
14	. FIRE-RESISTANCE RATED CONSTRUCTION			BC	110.3.4

ENERGY CODE PROGRESS INSP	PECTION	
15. FENESTRATION U—FACTOR AND PROD 16. AIR SEALING AND INSULATION — VISI 17. HVAC AND SERVICE WATER HEATING 18. HVAC AND SERVICE WATER HEATING 19. HVAC INSULATION AND SEALING 20. ELECTRICAL ENERGY CONSUMPTION 21. INTERIOR LIGHTING POWER 22. LIGHTING CONTROLS	UAL EQUIPMENT	(IA3), (IIA3) (IA6), (IIA6) (IB3), (IIB3) (IB4), (IIB4) (IB5), (IIB5) (IC1), (IIC1) (IC2), (IIC3)
23. MAINTENANCE INFORMATION		(ID1), (IID1)

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KENNETH FLATEN, KA

PROJECT NAME:

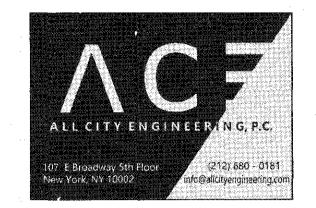
BC 110.2

178 MOTT STREET **NEW YORK, NY 10012 OFFICE CONVERSION**

DESIGN ENGINEER:



MEP ENGINEER:



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REV#: DATE DESCRIPTION:

DRAWING TITLE:

PLOT PLAN

PROJ. #: MW 618

SCALE: AS SHOWN DRAWING DATE: 06/26/2019

CHECKED BY: MW DRAWN BY: JL

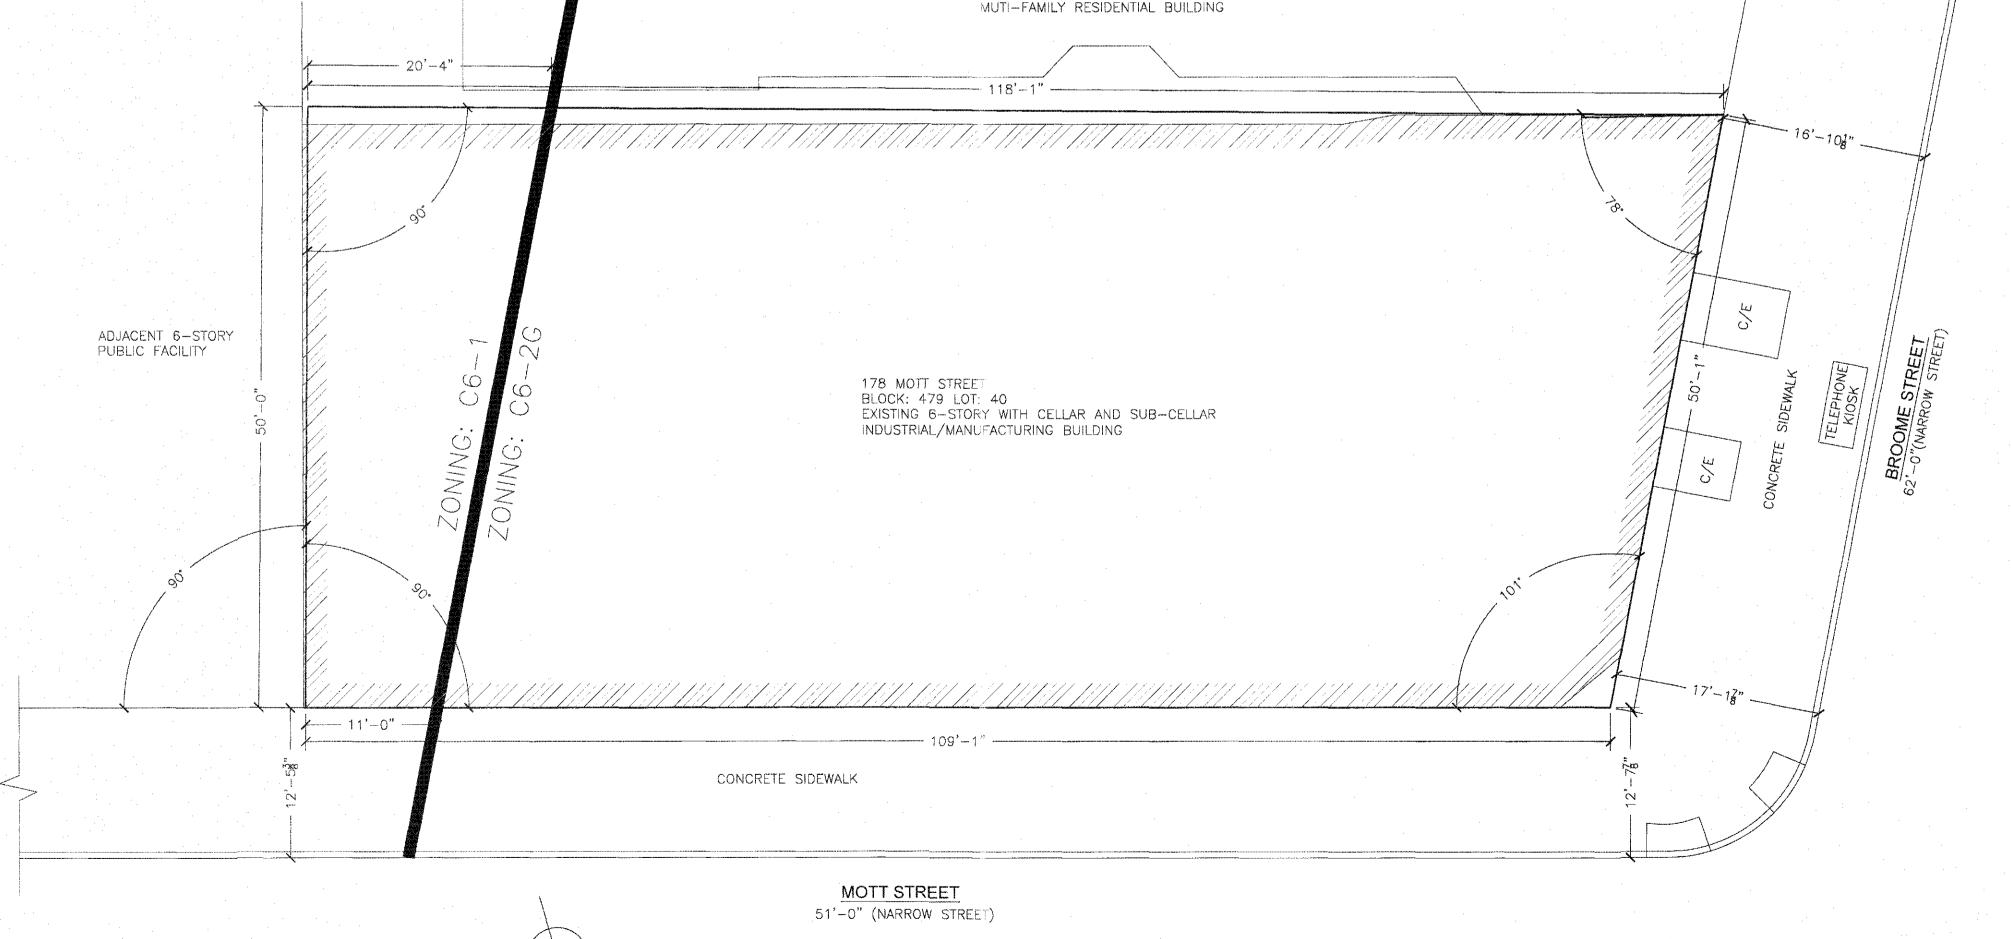
PROFESSIONAL SEAL

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DEPT BLDGS Job No. 123819305 Scan Code ESHS3431982



ADJACENT 5-STORY

SHEET 1 OF 30

GENERAL NOTES

- 1. THE GENERAL NOTES AND CONSTRUCTION DOCUMENTS HEREWITH SHALL APPLY TO THE WORK OF THIS PROJECT, AND SHALL BE CAREFULLY REVIEWED BY THE GENERAL CONTRACTOR AND ALL OF HIS SUB CONTRACTOR. THE GENERAL CONTRACTOR SHALL COORDINATE EACH SUBCONTRACTOR'S PARTICULAR WORK WITH ALL OTHER SUBCONTRACTOR'S WORK ASSOCIATED WITH THIS PROJECT. THE GENERAL CONTRACTOR SHALL SUPPLY THE SUBCONTRACTOR WITH COMPLETE SETS OF DRAWINGS. ANY CONFLICTS AND/OR DISCREPANCIES BETWEEN TRADES SHALL BE BROUGHT TO ARCH'S ATTENTION FOR RESOLUTION.
- 2. THE GENERAL CONTRACTOR AND EACH SUBCONTRACTOR SHALL CARRY WORKMEN'S COMPENSATION INSURANCE IN STATUTORY AMOUNTS AS REQUIRED BY LAW; LIABILITY, BODILY INJURY, AUTOMOTIVE . AND OTHER INSURANCES IN AMOUNTS AND FOR PERIODS SATISFACTORY TO THE GENERAL CONTRACTOR. TO THE FULLEST EXTENT PERMITTED BY LAW, THE GENERAL CONTRACTOR AND ALL OF HIS SUBCONTRACTOR SHALL INDEMNIFY AND HOLD HARMLESS THE ARCHITECT AND HIS CONSULTING ENGINEERS AND THEIR AGENTS AND EMPLOYEES FROM AND AGAINST ALL CLAIMS, DAMAGES, AND EXPENSES RESULTING FROM THE PERFORMANCE OF THE WORK ASSOCIATED WITH THIS PROJECT.
- 3. EXISTING CONDITIONS: BEFORE BIDDING, THE CONTRACTOR SHALL VISIT THE JOB SITE AND ASCERTAIN ALL EXISTING CONDITIONS WHICH WILL AFFECT HIS WORK. FAILURE TO DO SO WILL NOT BE ACCEPTED AS A REASON FOR REQUESTING EXTRA PAY WHEN THE EXISTING CONDITIONS RESULT IN EXTRA MATERIALS. ANY EXISTING CONDITIONS FOUND BY THE CONTRACTOR WHICH WILL ADVERSELY AFFECT THE WORK SHALL BE IMMEDIATELY BROUGHT TO THE ATTENTION OF THE ARCHITECT/ENGINEER. CORRECTION OF ANY DEFECTS SHALL BE COMPLETELY ASSESSED WITHOUT ADDITIONAL CHARGE AND SHALL INCLUDE REPLACEMENTS OR REPAIR OF ANY OTHER PHASE OF THE INSTALLATION WHICH MAY HAVE BEEN DAMAGED THEREBY.
- 4. ALL WORK PERFORMED FOR THIS PROJECT SHALL COMPLY WITH ALL NATIONAL STATE AND LOCAL CODES HAVING JURISDICTION, INCLUDING BUT NOT LIMITED TO THOSE LISTED IN THE CODE DATA PORTION OF THE DRAWINGS AND WITH THE REQUIREMENTS OF THE UTILITY COMPANIES WHOSE SERVICES SHALL BE UTILIZED ALL MODIFICATIONS REQUIRED BY THE BUILDING DEPARTMENT SHALL BE BROUGHT TO THE ATTENTION OF THE ARCHITECT PRIOR TO, OR AT THE TIME OF PERMITTING. ANY REQUIRED CHANGES WILL BE SHOWN, AS DETERMINED BY THE ARCHITECT, ON REVISED DRAWINGS ISSUED TO THE GENERAL CONTRACTOR.
- 5. THE GENERAL CONTRACTOR AND EACH SUBCONTRACTOR SHALL MAKE ARRANGEMENTS FOR, OBTAIN, AND PAY FOR ALL PERMITS, TESTS, INSPECTIONS, AND APPROVALS REQUIRED OR HIS PORTION OF WORK.
- 6. THE GENERAL CONTRACTOR AND EACH SUBCONTRACTOR SHALL BE RESPONSIBLE FOR NOTIFYING THE ARCHITECT OF ALL MANDATORY BUILDING INSPECTIONS REQUIRED BY THE BUILDING DEPARTMENT TO BE MADE BY THE ARCHITECT OR ANY OF HIS ENGINEERS UPON ISSUANCE OF THE PERMIT. THE GENERAL CONTRACTOR MUST ENSURE THAT INSPECTIONS PROCESS IS IN FULL COMPLIANCE WITH THE REQUIREMENTS OF ALL CODES AND AGENCIES HAVING JURISDICTION
- 7. THE GENERAL CONTRACTOR AND ALL SUBCONTRACTORS SHALL BE RESPONSIBLE TO BE AWARE OF ALL COMMENTS AND NOTES MADE BY THE BUILDING OFFICIAL UPON THE PERMITTED, SIGNED AND SEALED JOBSITE SET OF CONSTRUCTION DOCUMENTS, AND SHALL INCORPORATE ALL INFORMATION WITHIN THE APPLICABLE CONTRACTOR'S SCOPE OF WORK, IT SHALL, AS WELL, BE THE RESPONSIBILITY OF THE GENERAL CONTRACTOR TO KEEP AN AS-BUILT SET OF CONSTRUCTION DOCUMENTS, AND NOTIFY THE ARCHITECT OF ANY AND ALL CHANGES MADE DUE TO FIELD DIRECTIVES BY THE BUILDING INSPECTORS. AT SUBSTANTIAL COMPLETION OF THE PROJECT, THE GENERAL CONTRACTOR SHALL DELIVER THE AS-BUILT SET OF DRAWINGS TO THE ARCHITECT, WITH ALL AUTHORIZED FIELD CHANGES CLEARLY INDICATED IN RED INK
- 8. THE GENERAL CONTRACTOR AND ALL SUBCONTRACTORS SHALL BE INDIVIDUALLY RESPONSIBLE FOR THE PROTECTION OF BUILDING OCCUPANTS FROM ALL HAZARDS ASSOCIATED WITH HIS PARTICULAR WORK. THE CONTRACTOR SHALL PROVIDE, INSTALL AND MAINTAIN ALL BARRICADES, BARRIERS, AND DUST CONTROL SYSTEMS NECESSARY TO PROTECT THE HEALTH AND SAFETY OF THE BUILDING OCCUPANTS.
- 9. WRITTEN DIMENSIONS AND NOTES ARE TYPICAL FOR SIMILAR CONDITIONS, UNLESS OTHERWISE NOTED IN THE CONSTRUCTION DOCUMENTS. ALL DIMENSIONS AND CONDITIONS SHOWN ON THE DRAWINGS MUST BE VERIFIED BY THE CONTRACTOR PRIOR TO ORDERING ANY MATERIAL OR COMMENCING WITH ANY WORK,
- 10. THE GENERAL CONTRACTOR AND ALL SUBCONTRACTOR SHALL BE RESPONSIBLE FOR ANY CUTTING, FITTING, AND PATCHING THAT MAY BE REQUIRED TO PROPERLY COMPLETE THE WORK OF HIS CONTRACT. NO CONTRACTOR SHALL ENDANGER THE WORK OF ANY OTHER CONTRACTOR. ANY FEES/COSTS INCURRED TO REPAIR DEFECTIVE OR LIMITED WORK SHALL BE BORNÉ BY THE SUBCONTRACTOR RESPONSIBLE THEREFORE.
- 11. THE GENERAL CONTRACTOR SHALL SUBMIT PRODUCT APPROVALS, SHOP DRAWINGS, SAMPLES, AND EQUIPMENT SPECIFICATION SHEETS AS CALLED FOR IN TH CONSTRUCTION DOCUMENTS INCLUDING, BUT NOT LIMITED TO, THE FOLLOWING: ECTRICAL AND AIR CONDITIONING EQUIPMENT; PLUMBING FIXTURES AND BATHROOM ACCESSORIES; APPLIANCES; CABINETRY; AND FINISHES. ALL SUBMITTALS SHALL BE DELIVERED TO THE OWNER SUFFICIENTLY IN ADVANCE TO ALLOW FOR REVIEW AND CORRECTION OR APPROVAL. PROCUREMENT AND/OR FABRICATION SHALL NOT COMMENCE UNTIL SUBMITTALS ARE REVIEWED AND APPROVED BY THE OWNER. TH ARCHITECT'S APPROVAL OF A SUBMITTAL THAT IS NOT IN CONFORMANCE WITH THE CONTRACTOR DOCUMENTS DOES NOT RELIEVE THE CONTRACTOR OF THE RESPONSIBILITY TO CONFORM WITH THE CONTRACTOR DOCUMENTS.
- 12. ALL REQUIRED TESTS PERTAINING TO THIS PROJECT SHALL BE PERFORMED AT THE EXPENSE OF THE GENERAL CONTRACTOR, AND BY A LICENSED TESTING LABORATORY UNDER THE SUPERVISION OF A STATE REGISTERED ENGINEER. TEST RESULTS SHALL BE SUBMITTED EACH TIME A TEST IS COMPLETED.
- 13. THE GENERAL CONTRACTOR AND ALL APPLICABLE SUBCONTRACTOR SHALL FURNISH AND BE SOLELY RESPONSIBLE FOR ALL TEMPORARY BRACING AND SHORING REQUIRED TO MAINTAIN THE PLUMBNESS AND STABILITY OF ALL STRUCTURAL ELEMENTS. THIS SHALL APPLY EVEN TO THOSE STRUCTURAL MEMBERS NOT INDICATED IN THE CONSTRUCTION DOCUMENTS.
- 14. NO STRUCTURAL MEMBER SHALL BE CUT, REMOVED, OR MODIFIED (UNLESS SPECIFIED IN THE CONSTRUCTION DOCUMENTS) WITHOUT THE WRITTEN CONSENT OF THE ARCHITECT OR HIS ENGINEER.
- 15. ALL EXISTING DISTURBED OR DAMAGED SURFACES (I.E. DRYWALL, STUCCO, PAINT, ETC.), WITHIN THE AREA OF CONSTRUCTION, SHALL BE REPAIRED, AS NECESSARY, TO MATCH EXISTING FINISHES.
- 16. AFTER COMPLETION OF CONSTRUCTION, ALL WORK AREAS SHALL BE LEFT CLEAN AND FREE OF ANY PLASTER, PAINT SMEARS OR SPLATTERS, AND THE BUILDING IS TO BE BROOM CLEANED. 17. COORDINATION DRAWINGS: PREPARE COORDINATION DRAWINGS WHERE CAREFUL
- COORDINATION IS NEEDED FOR INSTALLATION OF PRODUCTS AND MATERIALS FABRICATION BY SEPARATE ENTITIES. PREPARE COORDINATION DRAWINGS WHERE LIMITED SPACE AVAILABILITY NECESSITATES MAXIMUM UTILIZATION OF SPACE FOR EFFICIENT INSTALLATION OF DIFFERENT COMPONENTS. 1. SHOW THE RELATIONSHIP OF COMPONENTS SHOWN ON SEPARATE SHOP DRAWINGS
 - . INDICATE REQUIRED INSTALLATION SEQUENCES. 3. COMPLY WITH REQUIREMENTS ALL SUBMITTAL AND SHOP DRAWING REQUIREMENTS.
- 18. COLD WEATHER CONSTRUCTION: THE GENERAL CONTRACTOR SHALL TAKE SPECIAL PRECAUTIONS AGAINST DAMAGE TO MATERIALS AND WORK INSTALLED IN COLD OR FREEZING WEATHER, BY PROVIDING ADEQUATE SPECIAL HEAT AND/OR COVERINGS TO PREVENT DAMAGE BY THE ELEMENTS. THE GROUND SURFACES UNDER FOOTINGS SHALL BE PROTECTED AGAINST PROST OR FREEZING.
- 19. ALL WORK SPECIFIED IN THE CONSTRUCTION DOCUMENTS, AND PERFORMED BY THE GENERAL CONTRACTOR OR HIS SUBCONTRACTORS, SHALL BE GIVEN A ONE (1) YEAR WARRANTY FROM THE DATE OF THE CITY OR COUNTY'S FINAL INSPECTION, AND WITH THE OWNER'S APPROVAL OF SATISFACTION. DURING THIS PERIOD, THE CONTRACTOR AGREES TO REPAIR AND/OR REPLACE, AS NECESSARY, ANY WORK PERFORMED UNDER HIS CONTRACT WHICH EFFECTIVE OR DAMAGED DUE TO CIRCUMSTANCES ASSOCIATED WITH THE WORKMANSHIP OF THE GENERAL CONTRACTOR'S WORK FORCE,
- R THAT OF HIS SUBCONTRACTOR. 20. THESE DRAWINGS AND SPECIFICATIONS ARE INSTRUMENTS OF CONSTRUCTION AND REMAIN THE PROPERTY OF THE ARCHITECT. ANY REPRODUCTION OF SAID DRAWINGS, WITHOUT THE WRITTEN CONSENT OF THE ARCHITECT, IS STRICTLY PROHIBITED BY COPYRIGHT PROTECTION LAWS.
- 21. PLANS: DRAWINGS ARE BASICALLY DIAGRAMS INTENDED TO DEPICT APPROXIMATELY EQUIPMENT LOCATIONS AND ARRANGEMENTS, NOT TO SHOW EVERY MINOR DETAIL. WHERE MANUFACTURER'S NAMES AND PRODUCT NUMBERS ARE INDICATED ON THE DRAWINGS IT SHALL BE CONSTRUED TO MEAN THE ESTABLISHING OF QUALITY AND PERFORMANCE STANDARDS OF SUCH ITEMS. ALL OTHER PRODUCT SUBSTITUTIONS MUST SUBMITTED TO THE ARCHITECT FOR APPROVAL. WHERE THERE IS A CONFLICT BETWEEN SPECIFICATIONS AND DRAWINGS, THE SPECIFICATIONS SHALL TAKE PRECEDENCE OVER DRAWINGS.
- 22. INTERFERENCE: THE CONTRACTOR SHALL COORDINATE HIS WORK WITH OTHER TRADES SO THAT INTERFERENCE WITH EXISTING CONDITIONS, CONDUITS, PIPING, EQUIPMENT, ARCHITECTURAL AND STRUCTURAL MEMBERS BE AVOIDED. THE CONTRACTOR SHALL PROVIDE AN ALLOWANCE TO RELOCATED ANY EXISTING PLUMBING MAINS, HVAC RUNS, BRANCH LINES OR ANY OTHER NONSTRUCTURAL ELEMENTS THAT INTERFERE WITH PROPOSED LAYOUT.

- 23. SUBSTITUTIONS: PRODUCTS AND MATERIALS CALLED OUT BY TRADE NAME AND/OR CATALOG NUMBERS ESTABLISH A STANDARD OF QUALITY, APPEARANCE, PERFORMANCE AND DIMENSION, CONTRACTORS SHALL BASE HIS PROPOSAL ON THOSE ITEMS AS THEY SHALL BE CONSIDERED AS A BASIS OF BIDDING. REQUESTS FOR SUBSTITUTION SHALL BE SUBMITTED IN WRITING TO THE ARCHITECT/ENGINEER, DEMONSTRATING THAT PRODUCT IS OF COMPARABLE AND BASIC DESIGN, CONSTRUCTION, STANDARDS AND WARRANTIES, DIMENSIONS TO FIT WITHOUT CHANGE, AND DOES NOT CAUSE EXTRA WORK TO OTHER TRADES. CONTRACTOR SHALL BE RESPONSIBLE FOR PROVIDING EQUALITY OF SUBSTITUTION: ARCHITECT/ENGINEER WILL, UNDER NO CIRCUMSTANCES BE REQUIRED, TO PROVE SUCH ITEM IS OR IS NOT FOR EQUAL EQUALITY TO THE SPECIFIED ITEM. ARCHITECT/ENGINEER EXPENSES INCURRED DUE TO CONTRACTOR'S REQUESTED REVISIONS OR SUBSTITUTIONS SHALL BE PAID BY CONTRACTOR.
- 24. ALL TRADES SHALL BE RESPONSIBLE FOR REVIEWING THE ENTIRE SET OF CONSTRUCTION DRAWINGS FOR ANY APPLICABLE WORK, CHANGE ORDERS FOR WORK DEPICTED ANYWHERE IN THE SET OF CONSTRUCTION DOCUMENTS SHALL NOT BE
- 25. SCHEDULING: CONTRACTOR SHALL COORDINATE WITH THE OWNER APPROPRIATE TIME TO PERFORM WORK, CONTRACTOR MUST BE AWARE OF VARYING AVAILABILITY OF APPROPRIATE TIME WINDOWS. CLOSE CONSULTATION WITH OWNER IS THEREFORE
- 26. NO DEVIATIONS SHALL BE MADE FROM THE CONTRACT DOCUMENTS OR PRODUCT SPECIFICATIONS WITHOUT WRITTEN APPROVAL OF THE ARCHITECT.
- 27. ALL PRODUCTS USED SHALL BE INSTALLED IN ACCORDANCE WITH THE MANUFACTURER'S RECOMMENDATIONS AND THE BEST PRACTICES OF THE TRADE.
- 28. RECORD DRAWINGS: MAINTAIN A COMPLETE SET OF PRINTS FOR INDICATING ALL CHANGES. USE COLORED PENS TO MARK CHANGES AT THE TIME OF EXECUTION AND DELIVER THE SET TO THE ARCHITECT/ENGINEER UPON COMPLETION, CONTRACTOR SHALL STAMP "AS BUILT" ON PRINTS AND PLANS, DATE AND SIGN IN INK.
- 29. THE GENERAL CONTRACTOR SHALL HAVE INSTALLED A JOB SITE TELEPHONE AND FAX WHICH SHALL BE IN OPERATION FROM THE START OF CONSTRUCTION UNTIL THE PERMANENT TELEPHONE SYSTEM IS INSTALLED.
- 30. THE CONTRACTOR SHALL FOLLOW ALL BUILDING MANAGEMENT AND/OR MUNICIPAL RULES & REGULATIONS INCLUDING BUT NOT LIMITED TO RULES REGARDING BARRICADES, DELIVERIES, PARKING, WORK HOURS, NOISE & BEHAVIOR.
- 31. GC SHALL COORDINATE HIS SCHEDULE WITH THOSE OF THE OWNER'S SEPARATE CONTRACT'S (IF ANY) INCLUDING:
 - A. MILLWORK CONTRACTOR STONE CONTRACTOR SAFE INSTALLER

G. CAMERA INSTALLER

- SECURITY AND ALARM INSTALLER I.T. WIRING AND TERMINATION DEVICE INSTALLER SYSTEMS FURNITURE INSTALLER
- 32. OWNER SUPPLIED ITEMS: AT ONSET OF PROJECT, GC SHALL NOTIFY OWNER OF QUANTITIES AND DELIVERY DATE REQUIREMENTS OF ALL OWNER PROVIDED ITEMS (IF ANY) INCLUDING:
 - A. CARPET LIGHTING FIXTURES & LAMPS WALL COVERINGS
 - DRAPERY CCTV CABLE
 - CABLE G. SOUND SYSTEM
- 33. CONTRACTOR SHALL BE RESPONSIBLE FOR REPLACING DAMAGED SPRAY-ON FIREPROOFING FROM DISTURBED STRUCTURAL STEEL.
- 34. ALL LIFE SAFETY EQUIPMENT SHOWN ON THESE CONSTRUCTION DRAWINGS ARE THE MINIMUM REQUIRED TO MEET ALL APPLICABLE CODES. PRIOR TO PROVIDING FINAL PRICING ALL CONTRACTORS SHALL MEET WITH THE LOCAL AUTHORITIES TO CONFIRM THAT QUANTITIES ARE ACCEPTABLE. CHANGE ORDERS WILL NOT BE APPROVED FOR ADDITIONAL LIFE SAFETY REQUESTED BY LOCAL AUTHORITIES ABOVE THOSE REQUIRED BY APPLICABLE CODES AND STANDARDS.
- 35. THE GENERAL CONTRACTOR SHALL LAYOUT & PAINT, ON THE FLOOR, THE LOCATION OF ALL WALLS, CEILING RECESSES, LIGHT FIXTURES, DIFFUSERS AND GRILLES IN THE AREA OF WORK FOR APPROVAL BY THE OWNER'S CONSULTANTS. PRIOR TO INSTALLATION OF INTERIOR AND EXTERIOR WALLS, THE CONTRACTOR SHALL LAYOUT THE LOCATION OF ALL SHOWCASES IN ORDER FOR THE ELECTRICAL CONTRACTOR TO LOCATE CEILING FIXTURES IN THESE AREAS.
- 36. BOTH THE GENERAL CONTRACTOR AND, IF APPLICABLE, THE MILLWORK SUBCONTRACTOR SHALL KEEP A FULL TIME SUPERINTENDENT ON THE JOB AT ALL TIMES. GENERAL CONTRACTORS SUPERINTENDENT SHALL REMAIN ON SITE FROM DATE OF SUBSTANTIAL COMPLETION TO OPENING DAY. MILLWORK SUPERINTENDENT SHALL REMAIN ON SITE THE COMPLETE WEEK FOLLOWING SUBSTANTIAL COMPLETION.
- 37. ALL WORK IS TO CONFORM WITH DRAWINGS AND SPECIFICATIONS WHETHER BY ARCH, ENGINEERS, TELECOMMUNICATIONS CONSULTANTS, AND/OR ANY AND ALL OTHER CONSULTANTS
- 38. THE CONTRACTOR IS TO MAINTAIN A COMPLETE AND UP TO DATE SET OF DRAWINGS. DRAWINGS ARE NOT TO BE SCALED ON THE JOB AT ALL TIMES INCLUDING THE CONTRACT DOCUMENTS AND SHOP DRAWINGS.
- 39. THE CONTRACTOR SHALL INCLUDE ALL CUTTING AND/OR CHOPPING AS REQUIRED FOR ANY AND ALL TRADES, INCLUDING THOSE WORKING FOR THE OWNER, REFER TO ALL DOCUMENTS. SAID CUTTING AND/OR CHOPPING SHALL BE PERFORMED IN ACCORDANCE WITH THE BUILDING RULES AND REGULATIONS.
- 40. THE CONTRACTOR IS TO PROVIDE ALL PIPE MOISTURE WRAPPING MATERIAL AS APPROVED FOR BUILDING STANDARD INSTALLATION.
- 41. THE CONTRACTOR IS TO PROVIDE THE INTEGRITY OF RATED PARTITIONS, COLUMNS AND BEAM FIREPROOFING IF DAMAGED, REPLACEMENT TO COMPLY WITH LOCAL CODES.
- 42. THE CONTRACTOR SHALL NOTIFY ARCH OF ANY ERRORS, OMISSIONS CONFLICTS OR AMBIGUITIES IN AND BETWEEN THE PLANS, DRAWINGS AND SPECIFICATIONS PRIOR T PROCEEDING WITH THAT PORTION OF THE WORK, IF SUCH NOTICE IS NOT FURNISHED ARCH, THE CONTRACTOR SHALL BE DEEMED TO HAVE INSPECTED THE PLANS, DRAWINGS, AND SPECIFICATIONS AND TO HAVE FOUND THEM IN PROPER FORM FOR EXECUTION
- 43. IT SHALL BE THE RESPONSIBILITY OF THE CONTRACTOR TO DISTRIBUTE ADEQUATE COPIES OF THESE DRAWINGS TO ALL APPLICABLE TRADES AT ALL TIMES DURING THE PROGRESS OF THE JOB (I.E. REVISIONS).
- 44. CONTRACTOR SHALL SUBMIT SHOP DRAWINGS AND/OR SAMPLES AS REQUIRED BY ARCH AND OTHER PROJECT CONSULTANTS FOR ARCH'S REVIEW PRIOR TO
- 45. REFER TO ALL OTHER PLANS INCLUDING ENGINEERING AND COMMUNICATIONS PLANS FOR RELATED WORK.
- 46. EACH CONTRACTOR AND SUBCONTRACTOR SHALL REVIEW THE ENTIRE SET OF CONTRACT DOCUMENTS AND ACKNOWLEDGE ALL CONDITIONS PERTINENT TO WORK. HE SHALL FULLY COORDINATE HIS WORK WITH THE INSTALLATION WORK BY OTHER TRADES AND MAKE NECESSARY FIELD ADJUSTMENTS AS REQUIRED TO ACCOMMODATE HIS WORK AT NO ADDITIONAL CHARGE TO OWNER. 47. ALL EXISTING CORE WALLS, PERIMETER WALLS, COLUMNS, AND ANY AND ALL EXISTING
- WALLS TO REMAIN ARE TO BE FIELD INSPECTED BY CONTRACTOR AT TIME OF BID AND ALL COSTS TO PATCH AND REPAIR ALL MENTIONED ITEMS TO A SMOOTH SURFACE FOR FINISHING ARE TO BE INCLUDED AT TIME OF BID. UNFINISHED OR BADLY DAMAGED CORE WALLS, COLUMNS AND MASONRY WALL SURFACES TO BE LAMINATED OR FURRED TIGHT WITH 5/8" GYPSUM BOARD TO 3" ABOVE HUNG CEILING AND TAPED AND SPACKLED READY FOR FINISHES, UNLESS OTHERWISE NOTED.
- 48. CONTRACTOR TO FIELD INSPECT EXISTING FLOOR SLAB CONDITIONS TO DETERMINE IF ANY FLOOR LEVELING IS REQUIRED. INFORM ARCH OF ANY WORK THAT WILL BE REQUIRED AND INCLUDE COSTS AT TIME OF BID.
- 49. PROVIDE FURRED ENCLOSURE AROUND ALL VERTICAL PIPES TO REMAIN.
- 50. THE CONTRACTOR SHALL BE RESPONSIBLE FOR COORDINATION OF ALL TRADES AND MATERIALS, WHETHER UNDER THE CONTRACT OR PROVIDED BY THE OWNER.
- 51. THE CONTRACTOR SHALL INCLUDE IN HIS BID ALL COSTS FOR DISCONNECTION. TRANSPORTATION, AND REINSTALLATION OF ALL ITEMS AT THE OWNER'S EXISTING PREMISES WHICH ARE DESIGNATED TO BE RELOCATED.
- 52. THE CONTRACTOR SHALL PROVIDE THE OWNER "AS BUILT" DRAWINGS FOR ALL
- 53. THE CONTRACTOR SHALL SUBMIT FOR APPROVAL COORDINATED SHOP DRAWINGS OF ALL TRADES HAVING AN IMPACT ON EACH OTHER, INCLUDING BUT NOT LIMITED HVAC, SPRINKLER, PLUMBING, CEILING, LIGHTING, ETC. IF CONFLICTS OCCUR AFTER INSTALLATION OF ANY TRADE'S WORK, IT SHALL BE THE RESPONSIBILITY OF THE CONTRACTOR TO RECTIFY SAME AT NO COST TO THE OWNER.
- 54. ALL CLEAN-UP AND CARTING FOR ANY AND ALL MATERIAL SHALL BE INCLUDED IN THE BID, WHETHER BY CONTRACTOR'S SUBS OR OWNER'S CONTRACTORS.
- 55. CONTRACTOR TO PROVIDE A SYSTEM OF TEMPORARY LIGHTS THROUGHOUT THE SPACE DURING DEMOLITION AND CONSTRUCTION

CONSTRUCTION NOTES

- 1. GENERAL CONTRACTOR SHALL COORDINATE, SUPPLY AND INSTALL ANY BLOCKING AS REQUIRED FOR THE SECURITY, MILLWORK, FURNITURE INSTALLER OR OTHER VENDORS OR SUB-CONTRACTORS.
- 2. THE GENERAL CONTRACTOR AND ALL APPLICABLE SUBCONTRACTOR SHALL PROVIDE AND INSTALL 2X WOOD BACKING BETWEEN STUDS FOR ANY BASE AND WALL-MOUNTED CABINETRY AND SURFACE-MOUNTED ACCESSORIES PRIOR TO THE INSTALLATION OF ANY WALLBOARD, PROVIDE BACKING EVEN IF CABINETRY AND ACCESSORIES ARE "BY OTHERS" OR "NOT IN CONTRACT" (NIC). CONTRACTOR SHALL MARK LOCATION OF BACKING ON WALLBOARD FOR THE USE OF THE CABINET/EQUIPMENT INSTALLERS.
- 3. GENERAL CONTRACTOR AND MILLWORK SHALL INSPECT AND FIELD VERIFY ALL WALL THICKNESS FOR DOOR JAMBS AND WALL PENETRATIONS.
- 4. ALL DIMENSIONS ARE TO FINISHED SURFACE UNLESS OTHERWISE NOTED.
- 5. DO NOT SCALE DRAWINGS. IF REQUIRED DIMENSIONS ARE NOT INDICATED, THE GENERAL CONTRACTOR SHALL NOTIFY THE ARCH FOR RESOLUTION.
- 6. GENERAL CONTRACTOR SHALL VERIFY ALL EXISTING CONDITION IN THE FIELD AND NOTIFY THE OWNER AND THE ARCHITECT OF ANY DISCREPANCIES IN THE PLANS. NOTIFICATION SHALL BE IN WRITING.
- 7. MILLWORK CONTRACTOR SHALL REVIEW ALL DWGS AND DETAILS FOR ALL MILLWORK.
- 8. GENERAL CONTRACTOR SHALL SUBMIT ALL SHOP DRAWINGS FOR APPROVAL. 9. MILLWORKER SHALL FIELD MEASURE EXACT FINISHED LOCATION F ALL MILLWORK
- AND ELECTRICAL RECEPTACLES AT THE JOBSITE PRIOR TO FABRICATION OF ANY MILLWORK, THE ARCHITECT SHALL BE NOTIFIED IMMEDIATELY OF ANY DISCREPANCIES OR CONFLICTS FOR RESOLUTION. 10. THE DRYWALL CONTRACTOR SHALL CLOSELY COORDINATE HIS WORK WITH THAT OF

OTHER TRADES. WHERE DRYWALL CONSTRUCTION IS IN CONFLICT WITH DUCTWORK, PLUMBING LINES, ETC., THIS CONTRACTOR SHALL PROVIDE ALL NECESSARY

CONTRACTORS. ALL WOOD GROUNDS, BRIDGING, BRACING, FRAMING ETC., SHALL BE

- BRIDGING AND BRACING REQUIRED TO SECURE DRYWALL AND TO MAINTAIN FIRE OR SOUND RARING WHERE REQUIRED. 11. GENERAL CONTRACTOR SHALL COORDINATE ALL WOOD GROUNDS, STEEL SUPPORTS AND ANY OTHER ITEM THAT IS EMBEDDED INTO THE DRYWALL PARTITIONS OR ENCLOSURES WHICH RELATES TO HIS WORK OR THE WORK OF ANY OTHER
- FIRE-RETARDED AS CALLED FOR BY THE BUILDING CODE AND GENERAL CONTRACTOR MUST SUBMIT AFFIDAVITS OF SUCH FIRE RETARDATION TO THE 12. WHERE EXISTING FIREPROOFING HAS BEEN REMOVED AT COLUMNS, BEAMS, ROOF/FLOOR DECKS OR ANY OTHER SURFACE NEW FIREPROOFING SHALL BE INSTALLED TO COMPLY WITH THE REQUIRED FIRE RATING. GENERAL CONTRACTOR IS
- TO VERIFY THIS CONDITION IN THE FIELD. 13. THE GENERAL CONTRACTOR IN COORDINATION WITH THE DRYWALL CONTRACTOR SEALL PROVIDE ALL LINE AND GRADE MARKINGS ON THE FINISHED FLOOR FOR ALL PARTITIONS FOR THE ARCHITECT'S APPROVAL BEFORE PROCEEDING WITH ANY WORK.
- 14. UNLESS OTHERWISE NOTED, ALL DIMENSIONS FOR PARTITIONS ARE FROM FINISH SURFACE TO FINISH SURFACE OR FROM FINISH SURFACE TO WINDOW MULLION.
- 15. ALL GYPSUM WALLBOARD PARTITIONS SHALL BE ERECTED AS SHOWN ON THE PLANS, DETAILS OR AS CALLED FOR IN THE SPECIFICATIONS (NOTES). ALL GYPSUM WALLBOARD PARTITION JOINTS SHALL BE LOCATED SO THAT PANELS EDGES FALL ON ALTERNATE STUDS. ALL JOINTS SHALL BE TAPED, SPACKLED AND FINISHED SMOOTH TO RECEIVE NEW WALL TREATMENT.
- 16. WALLS SHOWN ALIGNED WITH THE BASE BUILDING CORE STRUCTURE SHALL BE FLUSH AND SMOOTH WITH BASE BUILDING STRUCTURE AND SHALL BYPASS FACE OF COLUMNS OR MASONRY PARTITIONS WITH (1)LAYER OF 5/8" GYPSUM WALL-BOARD UNLESS NOTED OTHERWISE.
- 17. ALL DOORS IN DRYWALL OR MASONRY PARTITION SHALL BE SET 4" FROM OUTSIDE EDGE OF BUCK TO IMMEDIATE ADJACENT WALL, UNLESS OTHERWISE
- 18. ALL JOINTS IN NEW PARTITIONS, AS WELL AS JUNCTURES BETWEEN EXISTING AND NEW PARTITIONS, SHALL BE TAPED AND SPACKLED AND FINISHED SMOOTH.
- 19. WHERE INDICATED ON THE CONSTRUCTION PLAN, THE DRYWALL CONTRACTOR SHALL INSTALL CONTINUOUS, FULL HEIGHT ACOUSTICAL INSULATION BLANKETS BETWEEN THE STUDS UP TO THE BOTTOM OF THE STRUCTURE ABOVE LEAVING NO VOIDS OR SPACES.
- 20. THE CONTRACTOR SHALL APPLY AT LEAST TWO CONTINUOUS 1/4" DIAMETER CAULKING BEADS AT THE FLOOR AND CEILING CHANNEL RUNNÉRS AND ABUTTING CONSTRUCTION PRIOR TO THE INSTALLATION OF THE GYPSUM BOARD PANELS.
- 21. THE GENERAL CONTRACTOR SHALL PROVIDE SUFFICIENT FRAMING FOR ALL WAL OPENINGS FOR DUCTWORK, RETURN AIR OPENINGS, ACCESS PANELS AND GRILLE OPENINGS ABOVE AND BELOW HUNG CEILINGS. THESE ARE TO BE COORDINATED WITH HVAC. ENGINEERING DRAWINGS AND THE GENERAL CONTRACTOR'S MECHANICAL CONTRACTOR'S SHOP DRAWINGS. ALL SPACES OR GAPS SHALL BE PROPERLY SEALED FOR SOUNDPROOFING AND VIBRATION.
- 22. PROVIDE ALL NECESSARY CUT OUTS FOR THE INSTALLATION OF ELECTRICAL OUTLETS, SWITCHES AND/OTHER ELECTRICAL AND/OR MECHANICAL DEVICES.
- 23. WALLBOARD SHALL BE FURNISHED AND INSTALLED IN THE LONGEST AVAILABLE LENGTHS SO THE WALLBOARD PANELS SHALL EXTEND VERTICALLY IN ONE PIECE FROM FLOOR TO CEILING AND/OR SLABS, BEAMS OR DECKS ABOVE, AS REQUIRED.
- 24. TAPING AND SPACKLING SHALL BE 3 COAT APPLICATION.

ALL CONTROLLED INSPECTIONS.

- 25. THE GENERAL CONTRACTOR SHALL BE RESPONSIBLE FOR THE COORDINATION OF
- 26. THE GENERAL CONTRACTOR SHALL BE RESPONSIBLE, AND PAY FOR ALL FEES ASSOCIATED WITH THE OBTAINING OF ALL PERMITS REQUIRED BY ALL GOVERNMENTAL AGENCIES. THE GENERAL CONTRACTOR SHALL FILE THE DRAWINGS WITH THE PROPER AGENCIES IF THIS IS NOT PERFORMED BY THE OWNER. COORDINATE WITH OWNER PRIOR TO SUBMITTING FINAL BID.
- 27. THE CONTRACTOR IS TO PREPARE THE JOBSITE PARTITION LAYOUT FOR APPROVAL BY ARCH PRIOR TO ERECTING PARTITIONS, PROVIDE THREE (3) DAYS PRIOR NOTICE
- 28. THE CONTRACTOR SHALL TAPE OR MARK ON THE FLOOR SLAB AND/OR RAISED FLOOR, ALL FURNITURE SYSTEM PARTITIONS AND ELECTRICAL, TELEPHONE AND COMMUNICATION CABLE FEED FLOOR OUTLETS, FOR ARCH, APPROVAL PRIOR TO CORE DRILLING AND PLACEMENT OF OUTLETS.
- 29. ALL GYPSUM BOARD USED IN PARTITION TYPES TO BE FIRECODE, TYPE "X".
- 30. AT ALL POINTS WHERE PARTITION INTERSECTS WINDOW MULLION, THE CONTRACTOR SHALL PROVIDE SOUND BARRIER CONSTRUCTION AND A SOUNDPROOF FILLER INSTALLED WITHIN THE CONVECTOR ENCLOSURE THAT SHALL HAVE AN ACOUSTICA PERFORMANCE BETWEEN CONTIGUOUS PERIMETER SPACES THAT IS APPROPRIATE FOR THE DRYWALL PARTITION AND CEILING CONSTRUCTION.
- 31. ALL METAL STUDS TO BE MINIMUM GAUGE OF "US GYPSUM" #ST20 STUDS OR EQUAL, UNLESS OTHERWISE NOTED OR REQUIRED. 32. WHERE INTERFERENCE CAUSED BY DUCTWORK PREVENTS SECURING METAL STUDS TO
- SLAB, SECURE STUDS TO BLACK IRON AND SECURE BLACK IRON TO SLAB IN AN APPROVED METHOD. 33. WHERE EXISTING PARTITIONS HAVE BEEN REMOVED, ADJOINING WALLS, FLOORING, CEILING, ETC. ARE TO BE PARCHED FLUSH AND MADE READY TO RECEIVE NEW
- FINISHES. ALL REMAINING EXISTING (AND CORE) WALLS, EXTERIOR WALLS AND COLUMNS ARE TO BE CHECKED FOR CRACKS, WAVES, IMPERFECTIONS AND ARE TO BE SCARPATCHED IF NECESSARY TO PROVIDE A SMOOTH EVEN FINISH. 34. SHEETROCK PARTITION AND JOINTS ARE TO BE TAPED AND SPACKLED FLUSH, READY
- FOR SPECIFIED FINISHING TREATMENT. ALL EXPOSED CORNERS ARE TO BE FITTED WITH METAL CORNER BEADS. 35, CONTRACTOR TO INCLUDE COSTS FOR FLASH PATCHING OF SLAB AND/OR CUTTING OF
- DOOR OR FRAMES ETC. TO ALLOW TRUE, LEVEL AND STRAIGHT INSTALLATION OF ALL DOORS, FRAMES AND OTHER FIXED ITEMS AND FINISHES. 36. CONTRACTOR IS RESPONSIBLE FOR COSTS TO REPAIR CONVECTOR/RADIATOR COVERS DAMAGED BY DEMOLITION OR NEW CONSTRUCTION.

- 37. THE GENERAL CONTRACTOR AND/OR CONSTRUCTION MANAGER SHALL
- A. REVIEW THE WOODWORKER BID DOCUMENTS AND REVIEW THE SHOP DRAWINGS. B. COORDINATE THE ORDERING, DELIVERY AND INSTALLATION OF THE WOODWORK IN SUFFICIENT TIME TO AVOID DELAY IN THE OVERALL PROJECT SCHEDULE. INCLUDE PROPER AMOUNT OF TIME IN THE OVERALL PROJECT SCHEDULE FOR SHOP DRAWING AND SAMPLE SUBMISSIONS, FABRICATION AND INSTALLATION OF THE WOODWORK. C. COORDINATE WITH WOODWORKER AND OTHER TRADES TO ENSURE THAT WOODWORKER'S CONCEALED BLOCKING/GROUNDS ETC. ARE INSTALLED BEFORE
- WORK IS CLOSED UP BY OTHER TRADES D. FURNISH ARCHITECTURAL DOOR HARDWARE INCLUDING BUTT HINGES, LOCKSETS, LATCHSETS AND LEVERS, DOOR STOPS, AND FLOOR CLOSERS. COORDINATE WITH THE WOODWORKER. NOTE: CABINET/CASEWORK HARDWARE IS FURNISHED AND
- INSTALLED BY THE WOODWORKER. E. PROVIDE "FINISH COAT" PAINTING OF "WOODWORK DESIGNATED TO BE PAINTED". WOODWORKER TO PROVIDE ONE COAT OF PRIMER/SEALER. F. FURNISH AND INSTALL LIGHT FIXTURES AND SWITCHES IN WOODWORK. (I.E.
- UNDERCABINET LIGHT FIXTURES, FLUOR. TUBES, ETC. G. SCHEDULE FREIGHT ELEVATORS AND PROVIDE SECURÉ AREAS FOR DELIVERIES. H. PROVIDE ALL FIELD CUTTING, CHOPPING, AND PATCHING REQUIRED BY WOODWORKER.
- 38. ALL PARTITIONS MEETING PERIMETER WINDOW WALL TO BE CENTERED ON MULLIONS, UNLESS OTHERWISE NOTED.
- 39. ALL DIMENSIONS NOTED TO BE MAINTAINED. ANY DISCREPANCIES MUST BE IMMEDIATELY IDENTIFIED TO ARCH FOR FIELD ADJUSTMENT PRIOR TO PERMANENT WORK OR INSTALLATION.
- 40. ALL DRYWALL PARTITIONS IN BATHROOMS AND/OR WALLS RECEIVING TILE SHALL HAVE MOISTURE RESISTANT GYPSUM BOARD ON BATHROOM SIDE.
- 41: CONTRACTOR TO PROVIDE FLOOR MOUNTED ANCHOR SUPPORTS (INDUSTRY STANDARD 1/4" BENT STEEL PLATE, SECURE TO FLOOR) IN LOW HEIGHT DRYWALL PARTITIONS AT ALL UNSUPPORTED ENDS GREATER THAN 3'-0" FROM AND 90 DEGREE CONNECTION WITH ADJACENT PARTITION OR COLUMN.
- 42. CONTRACTOR IS RESPONSIBLE TO PROVIDE AND INSTALL ALL BLOCKING AND GROUND AS REQUIRED FOR THE INSTALLATION OF WINDOW BLINDS, DRAPERIES, AND CURTAINS USING FIRE RETARDANT WOOD.
- 43. GENERAL CONTRACTOR /CONTRACTOR TO COORDINATE W/FURNITURE VENDOR ON ALL FURNITURE SYSTEM LAYOUTS PRIOR TO ALL ELEC/DATA ROUGH-INS.
- 44. FOR PARTITIONS WHICH ARE OFFSET AT INTERSECTION WITH PERIMETER WINDOW WALL, THE PORTION OF PARTITION PARALLEL WITH WINDOW TO BE HELD 6" FROM CONVECTOR, UNLESS OTHERWISE NOTED. CONTRACTOR TO CONFIRM CLEARANCE WITH BUILDING MANAGER, ETC. AND ADJUST DIMENSION ACCORDINGLY.
- 45. CONTRACTOR TO FURNISH AND INSTALL ALL PLUMBING FIXTURES, PANTRY APPLIANCES AND ACCESSORIES IN TOILET ROOMS. SEE DETAILS FOR LOCATIONS AND SPECIFICATIONS.
- 46. IF APPLICABLE, BUILDING MGMT/LANDLORD WILL REPLACE EXISTING ROOF WITH NEW ROOFING AND FLASHING, INCLUDING THE REMOVAL OF ALL EXISTING MECHANICAL UNITS AND RELAYED ITEMS PRIOR TO NEW WORK ON ROOF THAT ARE SPECIFIED ON BID DOCUMENTS. ALL REQUIRED ROOFING REPAIR WORK INCLUDING NEW ROOF PAVERS INSTALLATION SHALL BE PERFORMED BY THE BUILDING ROOFING CONTRACTOR, UNDER THE GENERAL CONTRACTOR'S CONTRACT, SO AS TO KEEP THE ROOFING WARRANTY INTACK. GC TO VERIFY WITH BUILDING MGMT ON CORRECT ROOFING CONTRACTOR. SUBSTITUTE OF BUILDING ROOFING CONTRACTOR IS NOT PERMITTED.
- 47. IF APPLICABLE, WHERE INDICATED FOR NEW WINDOW INSTALLATIONS, REMOVAL AND RELOCATE EXISTING WINDOWS, FABRICATION AND INSTALLATIONS SHALL BE PERFORMED BY BUILDING WINDOW CONTRACTOR, UNDER GENERAL CONTRACTOR'S CONTRACT. GC SHALL COORDINATE WITH WINDOW CONTRACTOR ON ALL FIELD VERIFICATIONS AND FIELD DIMENSIONS. ALL WINDOW INSTALLATION REQUIREMENTS SHALL CONFORM TO BUILDING WINDOW CONTRACTOR'S SPECIFICATIONS. GC TO VERIFY WITH BUILDING MGMT ON CORRECT BUILDING WINDOW CONTRACTOR. SUBSTITUTE OF WINDOW CONTRACTOR IS NOT PERMITTED.

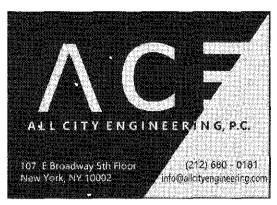
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178 MOTT STREET **NEW YORK, NY 10012** OFFICE CONVERSION

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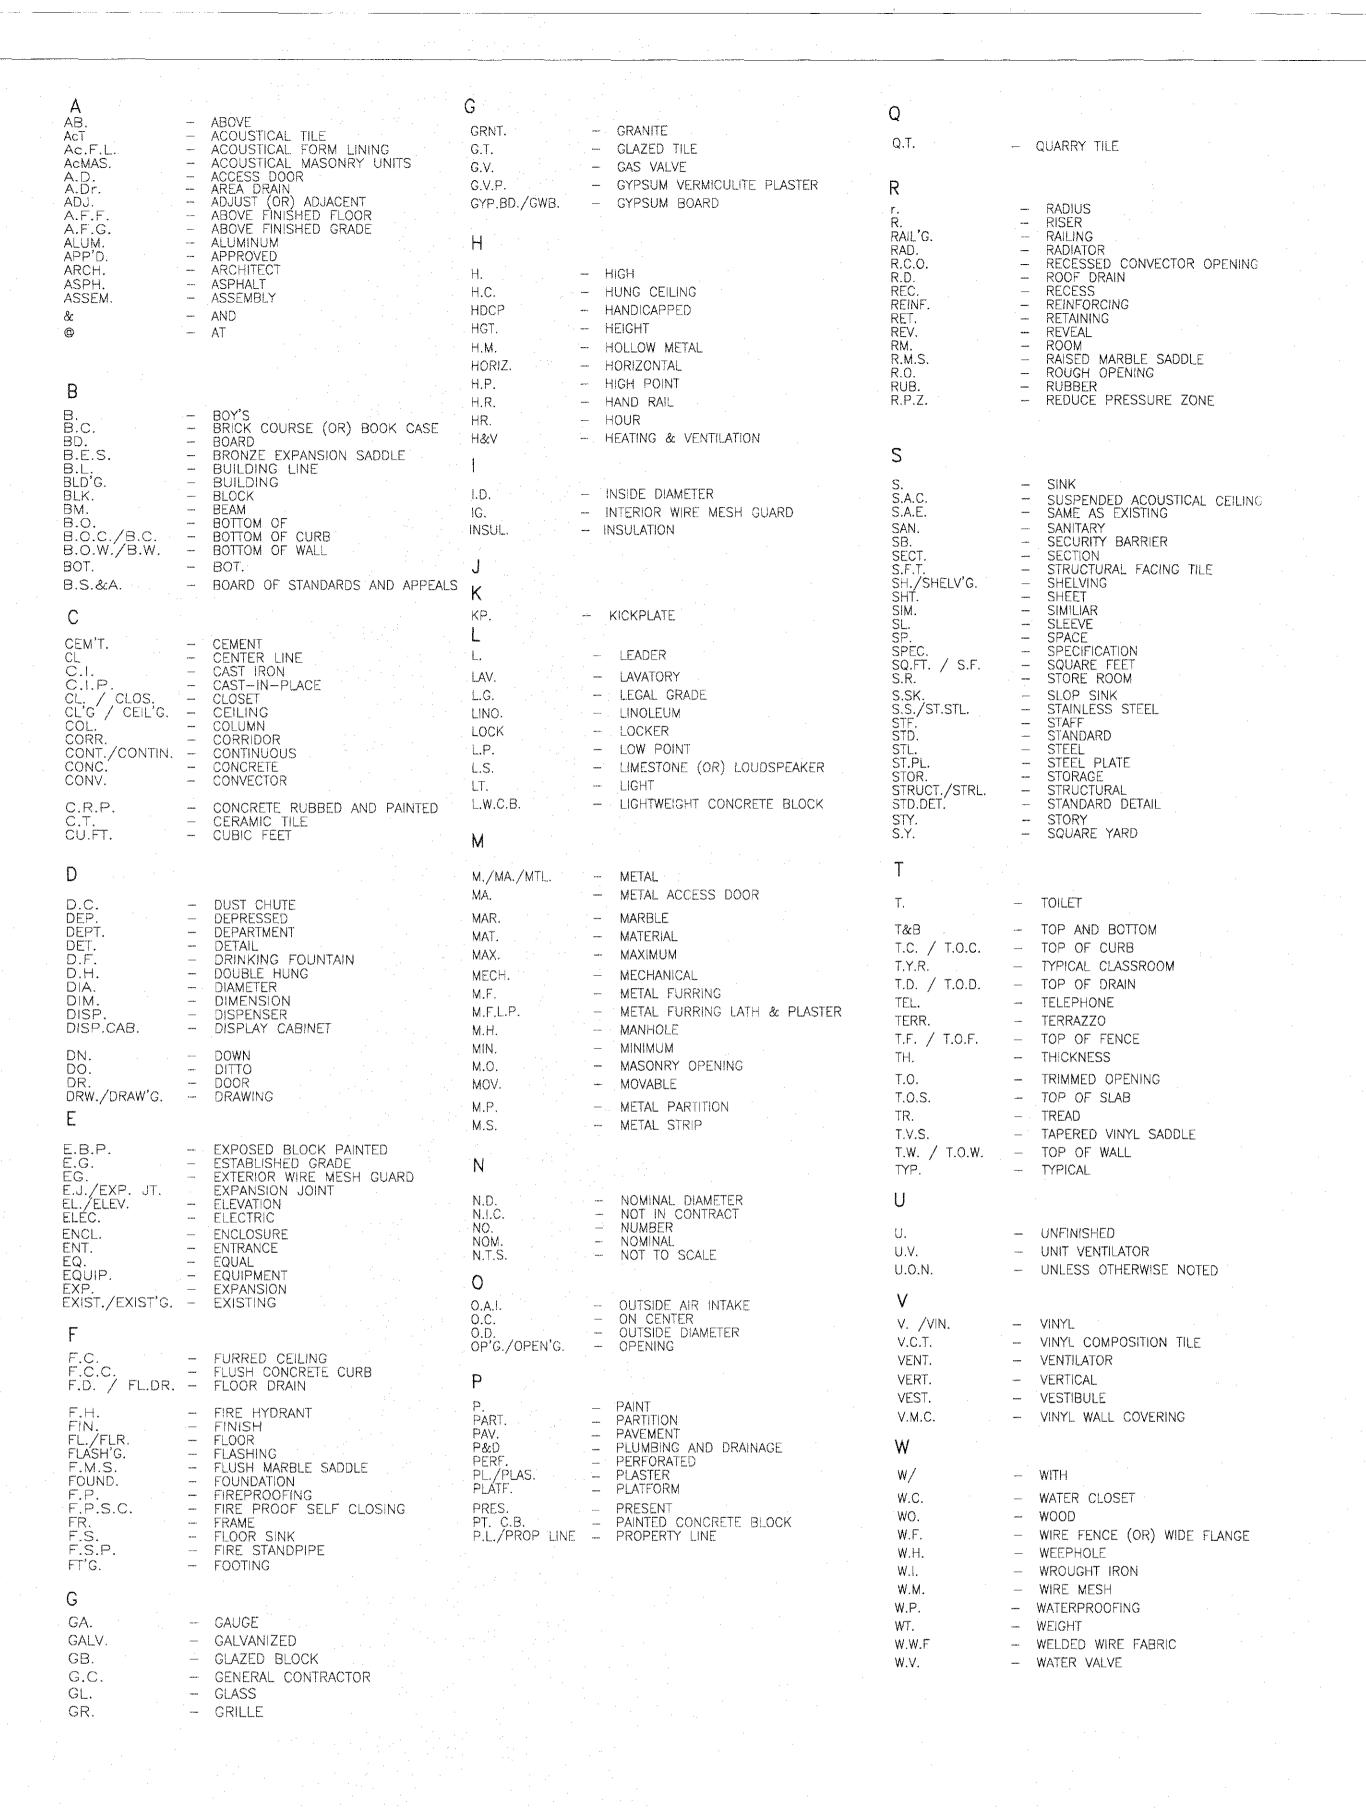
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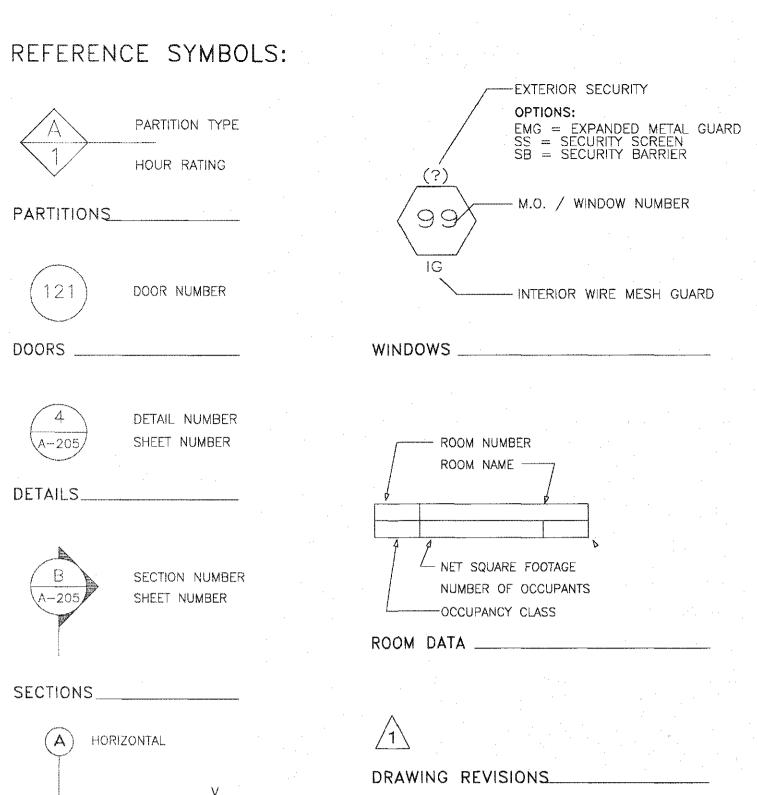
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ABBREVIATIONS AND SYMBOLS

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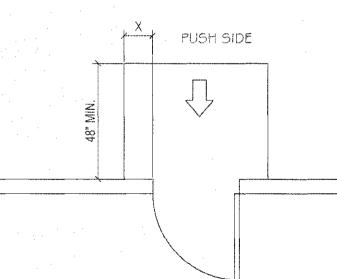
SHEET 3 OF 30

HANDICAPPED ADAPTABILITY NOTES:

- 1. ALL DETAILS AND GENERAL NOTES PERTAINING TO HANDICAPPED ADAPTABILITY SHALL SUPERSEDE OTHER DETAILS AND NOTES HEREIN.
- 2. ALL COMPONENTS OF SPACES REQUIRED TO COMPLY WITH HANDICAPPED ADAPTABILITY NOT COVERED BY THE SCOPE OF THESE DOCUMENTS SHALL ALSO COMPLY WITH REQUIREMENTS OF RS4-6, THIS INCLUDES (BUT NOT LIMITED TO) INTERIOR FINISHES, CONTROLS FOR BATHROOM, KITCHEN AND HVAC APPLIANCES AND FOR LIFTS AND ELEVATORS; AND HARDWARE FOR DOORS, WINDOWS AND STORAGE AREAS.
- 3. DOORWAYS INTENDED FOR USER PASSAGE SHALL HAVE A MINIMUM CLEAR OPENING OF 32 IN. WITH THE DOOR OPEN 90 DEGREES. MEASURED BETWEEN THE FACE OF THE DOOR AND THE STOP.
- 4. THE DOOR AND DOOR BUCK AT THE BATHROOM(S) SHALL BE DESIGNED AND CONSTRUCTED SO THAT REMOUNTING THE HINGES IS THE ONLY CHANGE REQUIRED TO SWING THE DOOR OUT.
- 5. THRESHOLDS AT DOORWAYS SHALL NOT EXCEED 3/4 IN. IN HEIGHT FOR EXTERIOR RESIDENTIAL SLIDING DOORS OR 1/2 IN. FOR OTHER TYPES OF DOORS. RAISED THRESHOLDS AND FLOOR LEVEL CHANGES AT ACCESSIBLE DOORWAYS SHALL BE BEVELED WITH A SLOPE NOT GREATER THAN 1:2. IN DWELLING UNITS THE HEIGHT OF THE WATER CLOSETS SHALL BE AT LEAST 15 IN. AND NO MORE THAN 19 IN. MEASURED TO THE TOP OF THE TOILET SEAT.
- STRUCTURAL REINFORCEMENT OR OTHER PROVISIONS SHALL BE MADE THAT WILL ALLOW INSTALLATION OF GRAB BARS IN THE LOCATIONS SHOWN IN THE DETAILS. 8. IF A CABINET IS PROVIDED UNDER THE LAVATORY, IT SHALL BE EASILY REMOVABLE FOR A WIDTH OF 30 IN. FINISHED FLOORING SHALL EXTEND UNDER THIS AREA TO THE WALL.
- 9. THE SINK AND SURROUNDING COUNTER IN ADAPTABLE DWELLING UNITS SHALL COMPLY WITH THE FOLLOWING REQUIREMENTS: (a) THE SINK AND SURROUNDING COUNTER SHALL BE ADJUSTABLE OR REPLACEABLE AS A UNIT AT VARIABLE HEIGHTS BETWEEN 28 IN. AND 36 IN. MEASURED
- FROM THE FINISHED FLOOR TO THE TOP OF THE COUNTER SURFACE OR SINK RIM. OR SHALL BE MOUNTED AT A FIXED HEIGHT NO GREATER THAN 34 IN. MEASURED FROM THE FINISHED FLOOR TO THE TOP OF THE COUNTER SURFACE OR SINK RIM. (b) WHERE SINKS ARE INSTALLED TO BE ADJUSTABLE IN HEIGHT, ROUGHEN PLUMBING SHALL BE LOCATED TO ACCEPT CONNECTIONS OF SUPPLY AND DRAINPIPES
- FOR SINKS MOUNTED AT THE HEIGHT OF 28 IN. (c) BASE CABINETS, IF PROVIDED, SHALL BE REMOVABLE UNDER THE FULL 30 IN. MINIMUM FRONTAGE OF THE SINK AND SURROUNDING COUNTER, THE FINISHED FLOORING SHALL EXTEND UNDER THE COUNTER TO THE WALL.
- (d) COUNTER THICKNESS AND SUPPORTING STRUCTURE SHALL BE 2 IN. MAXIMUM OVER THE REQUIRED CLEAR SPACE. (e) THERE SHALL BE NO SHARP OR ABRASIVE SURFACES UNDER SINKS, HOT WATER PIPES AND DRAINPIPES UNDER SINKS SHALL BE INSULATED OR OTHERWISE
- 10. OVERHEAD KITCHEN CABINETS (EXCEPT OVER STOVES, COOK TOPS AND PASS THROUGH) SHALL BE INSTALLED SO AS TO BE EASILY LOWERED TO A HEIGHT OF 48
- IN. FROM FINISHED FLOOR TO TOP OF LOWEST SHELF. 11. IF A MEDICINE CABINET IS PROVIDED ABOVE THE LAVATORY, THEN THE BOTTOM OF THE MEDICINE CABINET SHALL BE LOCATED WITH A USABLE SHELF NO HIGHER THAN 44 IN. ABOVE THE FLOOR.
- SECURELY AND SHALL NOT SLIP DURING USE. 12. AN IN-TUB SEAT OR A SEAT AT THE HEAD END OF THE TUB SHALL BE PROVIDED IN BATHTUBS. SEATS SHALL BE MOUNTED.
- 13. A SEAT SHALL BE PROVIDED IN SHOWER STALLS (SEE DETAIL). THE SEAT SHALL BE MOUNTED 17 IN. TO 19 IN. FROM THE BATHROOM FLOOR AND SHALL EXTEND THE FULL DEPTH OF THE STALL, THE SEAT SHALL BE ON THE WALL OPPOSITE THE CONTROLS.
- 14. A SHOWER SPRAY UNIT SHALL BE PROVIDED WITH A HOSE AT LEAST 60 IN. LONG THAT CAN BE USED AS A FIXED SHOWER HEAD OR AS A HANDHOLD SHOWER. IF AN ADJUSTABLE-HEIGH SHOWER HEAD MOUNTED ON A VERTICAL BAR USED, THE BAR SHALL BE INSTALLED SO AS NOT TO OBSTRUCT THE USE OF GRAB BARS.

- 15. THE 30 IN. KITCHEN WORK SURFACE SHOWN ON THE PLANS SHALL PROVIDE A WORK SURFACE THAT COMPLIES WITH THE FOLLOWING REQUIREMENTS: (a) THE COUNTER SHALL BE ADJUSTABLE OR REPLACEABLE AS A UNIT AS VARIABLE HEIGHTS 28 IN. AND 36 IN. MEASURED FROM THE FLOOR TO THE TOP COUNTER SÚRFACE, OR SHALL BE MOUNTED AT A FIXED HEIGHT, NO GREATER THAN 34 IN. MEASURED FROM THE FLOOR TO THE TOP OF THE COUNTER SURFACE. (b) BASE CABINETS, IF PROVIDED, SHALL BE REMOVABLE UNDER THE FULL 30 IN. MINIMUM FRONTAGE COUNTER. THE FINISHED FLOOR SHALL EXTEND COUNTER TO THE
- (c) COUNTER THICKNESS AND SUPPORTING STRUCTURE SHALL BE 2 IN. MAXIMUM OVER THE COUNTER TO THE WALL.
- (d) THERE SHALL BE NO SHARP OR ABRASIVE SURFACES UNDER SUCH COUNTERS. 16. WASHING MACHINES AND CLOTHES DRYERS IN COMMON-USE LAUNDRY ROOMS SHALL BE FRONT-LOADING.
- 17. CLOTHES RODS SHALL BE A MAXIMUM OF 54 IN. FROM THE FLOOR OR SHALL BE EASILY ADJUSTABLE TO THIS HEIGHT.
- 18. CHANGES IN GROUND LEVEL UP TO 1/4 IN. MAY BE VERTICAL AND WITHOUT EDGE TREATMENT, CHANGES IN LEVEL BETWEEN 1/4 IN. AND 1/2 IN. SHALL BE BEVELED WITH A SLOPE NO GREATER THAN 1:2.
- 19. DOORS TO HAZARDOUS AREAS SHALL BE MADE IDENTIFIABLE TO THE TOUCH BY A TEXTURED SURFACE ON THE DOOR HANDLE, KNOB, PULL OR OTHER OPERATING HARDWARE. THIS TEXTURED SURFACE MAY BE MADE CONTACT SURFACE. (HAZARDOUS AREAS INCLUDE LOADING PLATFORMS, BOILER ROOMS, STAGES, ETC.).
- 20. DETECTABLE WARNING TEXTURES ON WALKING SURFACES AS SHOWN ON PLANS SHALL CONSIST OF EXPOSED AGGREGATE CONCRETE, CUSHIONED SURFACES MADE OF RUBBER OR PLASTIC, RAISED STRIPS, OR GROOVES, TEXTURES SHALL CONTRAST WITH THAT OF THE SURROUNDING SURFACE RAISED STRIPS OR GROOVES SHALL COMPLY WITH RS 4-6. GROOVES MAY BE USED INDOORS ONLY.
- 21. AUDIBLE EMERGENCY ALARMS SHALL PRODUCE A SOUND THAT EXCEEDS THE PREVAILING EQUIVALENT SOUND LEVEL IN THE ROOM OR WHICHEVER IS LOUDER SOUND LEVEL FOR ALARM SIGNALS SHALL NOT EXCEED 120 DECIBELS.
- SPACE BY AT LEAST 15 DECIBELS OR EXCEEDS ANY MAXIMUM SOUND LEVEL WITH A DURATION OF 30 SECOND BY 5 DECIBELS. 22. VISUAL ALARMS SHALL BE FLASHING LIGHTS ARRANGED TO FLASH IN CONJUNCTION WITH THE AUDIBLE EMERGENCY ALARMS. THE FLASHING FREQUENCY OF VISUAL ALARMS
- SHALL BE APPROXIMATELY 1 HZ. SPECIALIZED SYSTEMS USING ADVANCED TECHNOLOGY MAY BE HANDICAPPED USERS OF THE BUILDING OR FACILITY. 23. SENSORY ALARMS PROVIDED FOR PERSONS WITH HEARING IMPAIRMENTS SHALL BE CONNECTED TO THE BUILDING EMERGENCY SYSTEM OR THERE SHALL BE A STANDARD 110 VOLT ELECTRICAL RECEPTACLE INTO WHICH AN ALARM UNIT CAN BE CONNECTED TO BE ACTIVATED BY THE BUILDING ALARM SYSTEM INSTRUCTIONS FOR USE OF THE AUXILIARY ALARM OR CONNECTIONS SHALL BE PROVIDED.
- 24. THE STRUCTURAL STRENGTH OF GRAB BARS, TUB AND SHOWER SEATS, FASTENERS, AND MOUNTING DEVICES SHALL MEET THE (112N) SHALL BE LESS THAN THE ALLOWABLE STRESS FOR THE MATERIAL OF THE GRAB BAR OR SEAT.
- FOLLOWING SPECIFICATIONS: (a) BENDING STRESS IN A GRAB BAR OR SEAT INDUCED BY THE MAXIMUM BENDING MOMENT FROM THE APPLICATION OF 250 LBF (b) SHEAR STRESS INDUCED IN A GRAB BAR OR SEAT BY THE APPLICATION OF 250 LBF (112N) SHALL BE LESS THAN THE ALLOWABLE SHEAR STRESS FOR THE MATERIAL OF THE GRAB BAR OR SEAT, IF THE CONNECTION BETWEEN THE GRAB BAR OR SEAT AND ITS MOUNTING BRACKET OR OTHER SUPPORT IS CONSIDERED TO BE
- FULLY RESTRAINED, THEN DIRECT AND TORSIONAL SHEAR STRESSES SHALL BE TOTALED FOR THE COMBINED SHEAR STRESS, WHICH SHALL NOT EXCEED THE ALLOWABLE (c) SHEAR FORCE INDUCED IN A FASTENER OR MOUNTING DEVICE FROM THE APPLICATION OF 250 LBF (112N) SHALL BE LESS THAN THE ALLOWABLE LATERAL LOAD OF
- EITHER THE FASTENER OR MOUNTING DEVICE OR THE SUPPORT STRUCTURE, WHICHEVER IS THE SMALLER ALLOWABLE LOAD. (d) TENSILE FORCE INDUCED IN A FASTENER BY A DIRECT FROM THE APPLICATION OF 250 LBF (112N) SHALL BE LESS THAN THE SUPPORTING STRUCTURE.
- (e) GRAB BARS SHALL NOT ROTATE WITHIN THEIR FITTING.

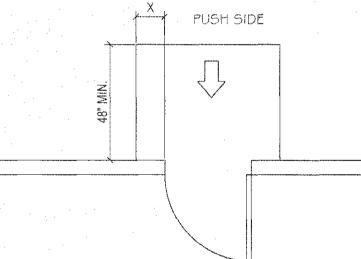
NOTED: X = 12" MIN. IF DOOR HAS BOTH A CLOSER & LATCH.



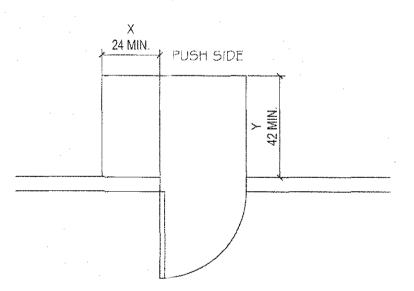
FRONT APPROACH - SWINGING DOOR

' PREFERRE

PULL SIDE



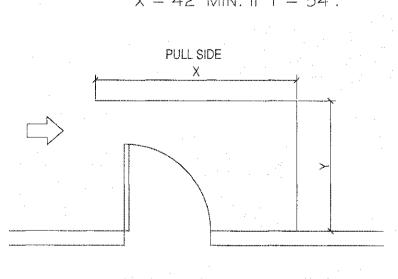
FRONT APPROACH - SWINGING DOOR



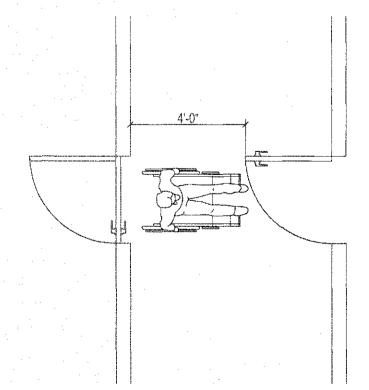
NOTED: Y = 48'' MIN. IF DOOR HAS CLOSER.

LATCH SIDE APPROACH - SWINGING DOOR

NOTED: X = 36'' MIN, IF Y = 60'': X = 42" MIN. IF Y = 54".

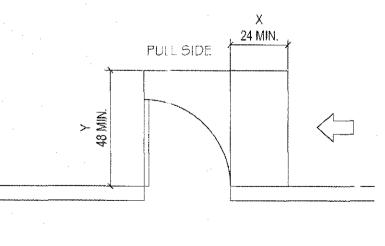


HINGE SIDE APPROACH - SWINGING DOOR

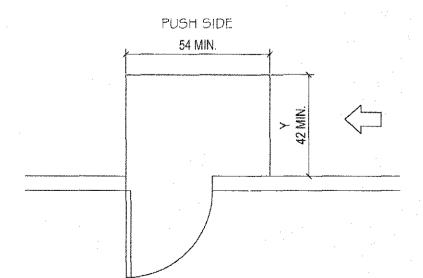


TWO HINGE DOOR IN SERIES

NOTED: Y = 54" MIN. IF DOOR HAS CLOSER.



<u>LATCH SIDE APPROACH - SWINGING DOOR</u>



NOTED: Y = 48" MIN. IF DOOR HAS BOTH A CLOSER & LATCH

SIDE APPROACH - SWINGING DOOR

HANDICAPPED ACCESSIBILITY NOTES

- 1. THIS PROJECT SHALL COMPLY WITH ALL FEDERAL AMERICANS WITH DISABILITY ACT REGULATION LATEST ANSI AND ALL LOCAL ACCESSIBILITY REGULATIONS AND LOCAL CODE.
- 2. THRESHOLDS SHALL BE NO HIGHER THAN 1/2" ABOVE THE FLOOR. EDGE TO BE BEVELED WITH SLOPE NO GREATER THAN 1 IN 2.
- 3. DOOR HARDWARE SHALL BE OF THE LEVER OR PUSH TYPE, MOUNTED 30" TO 44" ABOVE THE FLOOR AND BE OPERABLE WITH A MAXIMUM EFFORT OF 5 LBS FOR INTERIOR DOORS.
- 4. PROVIDE INTERNATIONAL SYMBOL OF ACCESSIBILITY AT ALL ENTRANCES AND WITH DIRECTIONAL SIGNS AS REQUIRED.
- 5. ACCESSIBLE DOORS MUST BE MINIMUM 3'-0" (WIDTH) X 6'-8" (HEIGHT) UON. MODIFY IF REQUIRED.
- 6. PROVIDE 18" CLEAR SPACE AT STRIKE/PULL SIDE ON 1ST FLOOR EXTERIOR AND INTERIOR DOORS. AND 12" CLEAR AT STRIKE/PUSH SIDE OF DOORS WITH CLOSERS.
- 7. FLOOR SHALL BE LEVEL THROUGHOUT.
- 8. SEE HANDICAP ACCESSIBILITY DRAWINGS FOR ADDITIONAL DETAILS AND REQUIREMENTS. REFER TO DETAILS ON HANDICAP SHEETS WHICH SUPERSEDE ALL OTHER INFORMATION.

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NEW YORK, NY 10012 **OFFICE CONVERSION**

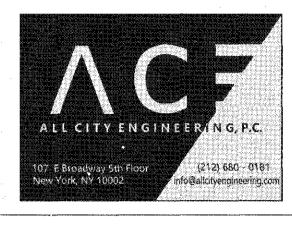
178 MOTT STREET

DESIGN ENGINEER:

PROJECT NAME:



MEP ENGINEER:



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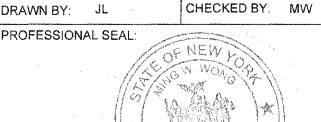
HANDICAPPED ADAPTABILITY NOTES

PROJ. #: MW 619

SCALE: AS SHOWN

DRAWING DATE: 06/26/2019

DRAWN BY: JL



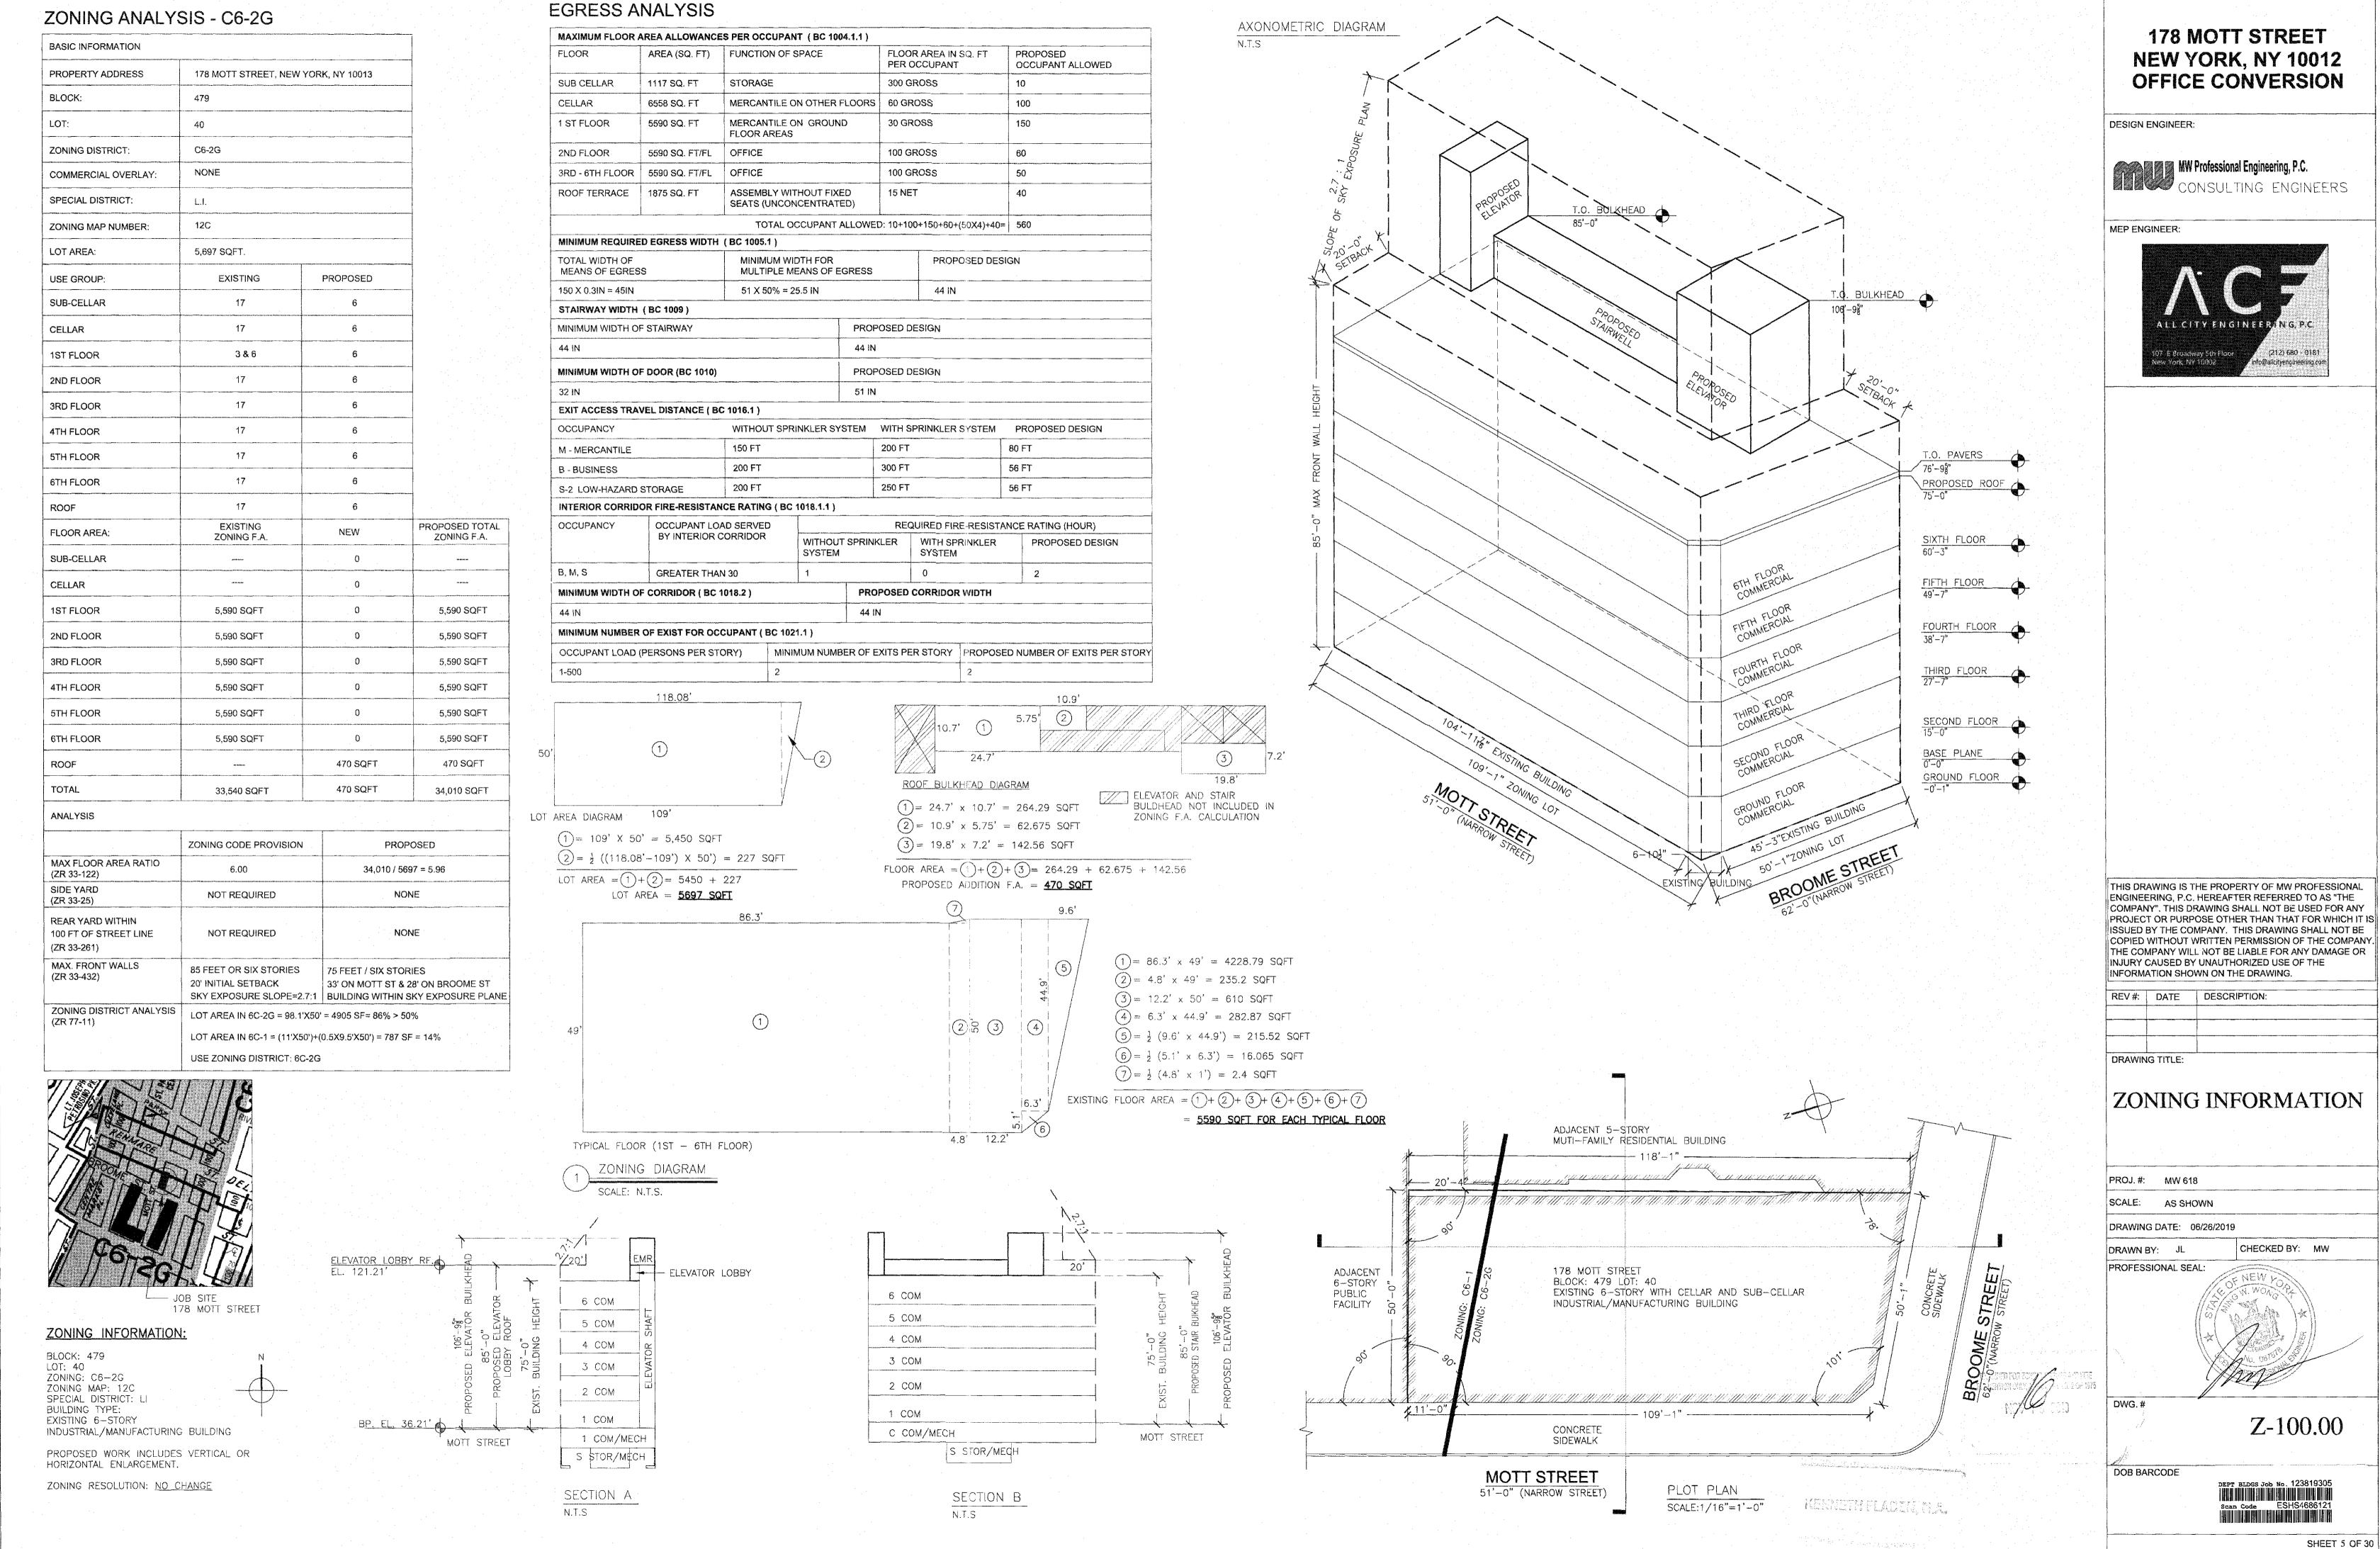
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SHEET 4 OF 30



PROJECT NAME:

TO THE BEST OF MY KNOWLEDGE, BELIEF AND PROFESSIONAL JUDGEMENT, ALL WORK UNDER THIS APPLICATION IS IN COMPLIANCE WITH THE NEW YORK CITY ENERGY CONSERVATION CODE, USING ENERGY CONSERVATION CONSTRUCTION CODE OF NEW YORK CITY YEAR 2016 CHAPTER C3 AND C4.

INSPECTION/TEST

IIC4 EXTERIOR LIGHTING POWER:

TRANSFORMERS.

LIGHTING CONTROLS:

CONTROLS

OPERATION.

EXIT SIGNS:

WATTAGE.

OTHER

COMPLETENESS.

CONTROLS, INCLUDING:

•OCCUPANT SENSORS

INSTALLED LIGHTING SHALL BE FINAL

SOURCE EFFICACY AND/OR THE AND

EACH TYPE OF REQUIRED LIGHTING FINAL

INSTALLED EXIT SIGNS SHALL BE FINAL

THE LABEL INDICATES THAT THEY DO AND

CONSTRUCTION DOCUMENTS FOR AND

VISUALLY INSPECTED TO VERIFY THAT THEY COMPLY WITH THE RESPECTIVE ENERGY REQUIREMENTS IN THE

VISUALLY INSPECTED TO VERIFY THAT ELECTRICAL

ELECTRIC MOTORS (INCLUDING BUT PRIOR TO NOT LIMITED TO FAN MOTORS):

FINAL

MAINTENANCE MANUALS FOR SIGNOFF

AND ELECTRICAL EQUIPMENT AND OF

MAINTENANCE SHALL BE REVIEWED OF

EQUIPMENT AND SYSTEMS BEFORE

SUCH MANUALS ARE PROVIDED TO THE OWNER. LABELS REQUIRED FOR

SUCH EQUIPMENT OR SYSTEMS SHALL

BE INSPECTED FOR ACCURACY AND

MECHANICAL, SERVICE HOT WATER OR ISSUANCE

SYSTEMS REQUIRING PREVENTIVE CERTIFICATE

FOR APPLICABILITY TO INSTALLED OCCUPANCY

WHERE REQUIRED BY THE ELECTRICAL

ENERGY CODE COMPLIANCE, MOTOR CONSTRUCTION INSPECTION

NOT EXCEED MAXIMUM PERMITTED CONSTRUCTION

LAMPS, BALLASTS AND RELEVANT

LIGHT—REDUCTION CONTROLS

 SLEEPING UNIT CONTROLS EXTERIOR LIGHTING CONTROLS

SHALL BE VERIFIED BY VISUAL

INSPECTION AND TESTED FOR FUNCTIONALITY AND PROPER

NOT LIMITED TO FAN MOTORS):

CONSTRUCTION DOCUMENTS.

MAINTENANCE INFORMATION:

 AUTOMATIC LIGHTING SHUT-OFF DAYLIGHT ZONE CONTROLS

VERIFIED FOR COMPLIANCE WITH ELECTRICAL

VISUAL INSPECTION OF FIXTURES, INSPECTION

LIGHTING POWER ALLOWANCE BY CONSTRUCTION

• MANUAL INTERIOR LIGHTING CONSTRUCTION

PERIODIC (MINIMUM) | REFERENCE | ECC OR OTHER

CRITERIA

APPROVED

DOCUMENTS

CONSTRUCTION

DOCUMENTS,

NARRATIVES

APPROVED

APPROVED

DOCUMENTS

APPROVED

DOCUMENTS,

INCLUDING

ELECTRICAL

DRAWINGS

APPLICABLE;

GUIDELINE 4: PREPARATION

OF OPERATING

MAINTENANCE DOCUMENTATION FOR BUILDING SYSTEMS

WHERE

ASHRAE

DOCUMENTS

CONSTRUCTION ASHRAE

CONSTRUCTION | ASHRAE

CONSTRUCTION | C408.2.5.2;

INCLUDING

CONTROL

SYSTEM

PRIOR TO

ELECTRICAL

PRIOR TO

ECC CHAPTER C5) OR OTHER

STANDARD (SEE | CITATION

CONSTRUCTION | ASHRAE

C405.6;

1RCNY

C405.2;

ASHRAE

(AS

90.1-9.4.1;

MODIFIED

BY SECTION

ECC A102)

C405.4;

90.1-9.4.2

C403.2.10;

90.1-10.4

ASHRAE

6.7.2.2,

8.7.2.

9.7.2.2

90.1 - 4.2.2.3

90.1-9.4.3;

(3)(v)(C)4

SS101-07(c)

COM	PLIANCE - COMMERCIAL BUILD	I		
	INSPECTION/TEST	PERIODIC (MINIMUM)	REFERENCE STANDARD (SEE ECC CHAPTER C5) OR OTHER CRITERIA	ECC OR OTHER CITATION
IIA	ENVELOPE INSPECTIONS	<u> </u>		1
IIA1	PROTECTION OF EXPOSED FOUNDATION INSULATION: INSULATION SHALL BE VISUALLY INSPECTED TO VERIFY PROPER PROTECTION WHERE APPLIED TO THE EXTERIOR OF BASEMENT OR CELLAR WALLS, CRAWL—SPACE WALLS AND/OR THE PERIMETER OF SLAB—ON—GRADE FLOORS.	DURING FOUNDATION WORK AND PRIOR TO	APPROVED CONSTRUCTION DOCUMENTS	C303.2.1; ASHRAE 90.1-5.8.1.7
IIA2	COMPONENT OF THE CONDITIONED SPACE ENVELOPE AND AT JUNCTIONS	VERIFY CONTINUOUS ENCLOSURE WHILE WALLS, CEILINGS AND FLOORS ARE OPEN	DOCUMENTS	C303.1, C303.1.1, C303.1.2, C402.1, C402.2; ASHRAE 90.1-5.5, 5.6 OR 11; 5.8.1
IIA3	FENESTRATION U-FACTOR AND PRODUCT RATINGS: U-FACTORS, SHGC AND VT VALUES OF INSTALLED FENESTRATION SHALL BE VERIFIED BY VISUAL INSPECTION FOR CONFORMANCE WITH THE U-FACTORS, SHGC AND VT VALUES IDENTIFIED IN THE CONSTRUCTION DRAWINGS, EITHER BY VERIFYING THE MANUFACTURER'S NFRC LABELS OR, WHERE NOT LABELED, USING THE RATINGS IN ECC TABLES C303.1.3(1), (2) AND (3).	DURING INSTALLATION	APPROVED CONSTRUCTION DRAWINGS; NFRC 100, NFRC 200	C303.1, C303.1.3, C402.3; ASHRAE 90.1-5.5; 5.6 OR 11; 5.8.2
IIA4	FENESTRATION AIR LEAKAGE: WINDOWS AND SLIDING OR SWINGING DOOR ASSEMBLIES, EXCEPT SITE-BUILT WINDOWS AND/OR DOORS, SHALL BE VISUALLY INSPECTED TO VERIFY THAT INSTALLED ASSEMBLIES ARE LISTED AND LABELED TO THE REFERENCED STANDARD.	DURING INSTALLATION	AAMA/WDMA/CSA	C402.4.3; ASHRAE 90.1-5.4.3.2
	FOR CURTAIN WALL, STOREFRONT GLAZING, COMMERCIAL ENTRANCE DOORS AND REVOLVING DOORS, THE TESTING REPORTS SHALL BE REVIEWED TO VERIFY THAT THE INSTALLED ASSEMBLY COMPLIES WITH THE STANDARD CITED IN THE APPROVED PLANS.			
IIA5	FENESTRATION AREAS: DIMENSIONS OF WINDOWS, DOORS AND SKYLIGHTS SHALL BE VERIFIED BY VISUAL INSPECTION.	FINAL CONSTRUCTION INSPECTION	CONSTRUCTION DOCUMENTS	C402.3; ASHRAE 90.1-5.5.4.2, 5.6 OR 11
IIA6	AIR SEALING AND INSULATION - VISUAL INSPECTION: OPENINGS AND PENETRATIONS IN THE BUILDING ENVELOPE, INCLUDING SITE—BUILT FENESTRATION AND DOORS, SHALL BE VISUALLY INSPECTED TO VERIFY THAT A CONTINUOUS AIR BARRIER AROUND THE ENVELOPE FORMS AN AIR—TIGHT ENCLOSURE.	DURING ENVELOPE	APPROVED CONSTRUCTION DOCUMENTS; ASTM E283;	C402.4; ASHRAE 90.1-5.4.3.1
	THE PROGRESS INSPECTOR SHALL VISUALLY INSPECT TO VERIFY THAT MATERIALS AND/OR ASSEMBLIES HAVE BEEN TESTED AND MEET THE REQUIREMENTS OF THE RESPECTIVE STANDARDS, OR THAT THE BUILDING IS TESTED AND MEETS THE REQUIREMENTS OF THE STANDARD, IN ACCORDANCE WITH THE STANDARD(S) CITED IN THE APPROVED PLANS.			
IIA7	PROJECTION FACTORS: WHERE THE ENERGY ANALYSIS UTILIZED A PROJECTION FACTOR > 0, THE PROJECTION DIMENSIONS OF OVERHANGS, EAVES OR PERMANENTLY ATTACHED SHADING DEVICES SHALL BE VERIFIED FOR CONFORMANCE WITH APPROVED PLANS BY VISUAL INSPECTION.	FINAL CONSTRUCTION	APPROVED CONSTRUCTION DOCUMENTS; INCLUDING ENERGY ANALYSIS	C402.3; ASHRAE 90.1-5.5.4, 5.6 OR 11
IIA8	LOADING DOCK WEATHERSEALS: WEATHERSEALS AT LOADING DOCKS SHALL BE VISUALLY VERIFIED.		APPROVED CONSTRUCTION DOCUMENTS	C402.4.6; ASHRAE 90.1-5.4.3.3
IIA9	VESTIBULES: REQUIRED ENTRANCE VESTIBULES SHALL BE VISUALLY INSPECTED FOR PROPER OPERATION.		APPROVED CONSTRUCTION DOCUMENTS	C402.3; ASHRAE 90.1-5.4.3.4
IIC IIC1	ELECTRICAL POWER AND LIGHTING SYSTEM ELECTRICAL ENERGY CONSUMPTION: THE PRESENCE AND OPERATION OF INDIVIDUAL METERS OR OTHER MEANS OF MONITORING INDIVIDUAL APARTMENTS SHALL BE VERIFIED BY VISUAL INSPECTION FOR ALL APARTMENTS AND WHERE REQUIRED IN A COVERED TENANT SPACE.	PRIOR TO FINAL ELECTRICAL AND	APPROVED CONSTRUCTION DOCUMENTS	C405.7
IIC2	LIGHTING IN DWELLING UNITS: LAMPS IN PERMANENTLY INSTALLED LIGHTING FIXTURES SHALL BE VISUALLY INSPECTED TO VERIFY	ELECTRICAL AND	APPROVED CONSTRUCTION DOCUMENTS	C405.1; ASHRAE 90.1-9.1.1
IIC3	VERIFIED FOR COMPLIANCE WITH THE LIGHTING POWER ALLOWANCE BY VISUAL INSPECTION OF FIXTURES.		APPROVED CONSTRUCTION DOCUMENTS	C405.5, C406.3; ASHRAE 90.1-9.1, 9.2, 9.5, 9.6; 1RCNY SS101-07(c) (3)(v)(C)4

THE NEW YORK CITY ENERGY CONSERVATION CODE 2016 (NYCECC)

NYCECC CITATION C402.1.3, C402.2, TABLES C402.1.3, C402.1.4	PROVISION ROOF ASSEMBLY — INSULATION ENTIRELY ABOVE ROOF DECK	NEW COMPOSITE METAL DECK ROOF	PROPOSED DESIGN VALUE 6" RIGID INSULATION (R-30) ABOVE DECK	CODE PRESCRIPTIVE VALUE (ECC) MINIMUM R-30ci	A-300 (ROOF CONSTRUCTION DETAIL)
TABLES C402.1.3, C402.1.4 OR SECTION C402.2	WALLS, ABOVE-GRADE: MASS	8" CMU W/CONTINUOUS RIGID INSULATION AND STUCCO FINISH	2" RIGID INSULATION (R-10), 3.5" FIBERGLASS INSULATION (R-13) AND 8" CMU (R-1)	MINIMUM R-11.4ci	A-300 (EXTERIOR WALL DETAIL)
ABLES C402.1.3, 402.1.4 OR SECTION 402.2	BELOW-GRADE WALLS	THERMAL INSULATION ON THE INTERIOR OF CELLAR WALL		MINIMUM R-7.5ci	A-300 (FOUNDATION WALL DETAIL)
ABLES C402.1.3, C402.1.4 OR SECTION C402.2	FLOORS: MASS	THERMAL INSULATION AT NEW CONCRETE FLOOR OF CELLAR	3" RIGID FORM INSULATION (R-15)	MINIMUM R-10.4ci	A-300 (FOUNDATION WALL DETAIL)
TABLES C402.1.3, 0402.1.4 OR SECTION 0402.2	FLOORS: JOIST/FRAMING	THERMAL INSULATION AT NEW STEEL-JOIST FLOOR OVER UNCONDITIONED SPACE		MINIMUM R-30	A-300 (ROOF CONSTRUCTION DETAIL)
C402.1.3, C402.1.4	ASSEMBLY U-FACTOR C-FACTOR OR F-FACTOR-BASED METHOD	,8" BLOCK WALL WITH R-13 BATT INSULATION IN METAL STUDS & R-10 CONTINUOUS EXTERIOR INSULATION	MASS WALL U-FACTOR = 1/(1+13+10) = 0.042	MASS WALL: MAXIMUM U-FACTOR = 0.090	A-300 (EXTERIOR WALL DETAIL)
C402.4, TABLE C402.4	FENESTRATION (PRESCRIPTIVE)	FENESTRATION REQUIREMENTS	ALL WINDOWS ARE OPERABLE U-FACTOR = 0.40 SHGC = 0.40	MAXIMUM U-FACTOR = 0.38 (FIXED) MAXIMUM U-FACTOR = 0.40 (OPERABLE) MAXIMUM SHGC = 0.40	A-002, A-003 (FLOOR PLANS AND WINDOW SCHEDULE)
2402.4.1	MAXIMUM AREA	WINDOW TO WALL RATIO	FRONT: 18% REAR: 29%	30% MAXIMUM	A-005 (BUILDING ELEVATIONS CALCULATIONS)
C402.5	AIR LEAKAGE — THERMAL ENVELOPE (MANDATORY)		BUILDING THERMAL ENVELOPE TO COMPLY WITH SECTIONS C402.5.1 THROUGH C402.5.8.	THE THERMAL ENVELOPE OF THE BUILDING MUST COMPLY WITH SECTIONS C402.5.1 THROUGH C402.5.8. PRESSURE DIFFERENTIAL OF 0.3 INCH WATER GAUGE. AIR LEAKAGE RATE 0.40 CFM/SF MAXIMUM. MUST COMPLY WITH SECTIONS C402.5.5, C402.5.6, AND C402.5.7.	A-002, A-003 (AIR LEAKAGE NOTES)
C402.5.1	BARRIERS	AIR BARRIER MATERIAL	CONTINUOUS AIR BARRIER - ALL JOINTS TO BE SEALED WITH GASKET OR ADHESIVE.	A CONTINUOUS AIR BARRIER FOR THE OPAQUE BUILDINGS ENVELOPE SHALL COMPLY WITH SECTION C402.5.1.2.1 OR C402.5.1.2.2.	A-300 (AIR SEALING DETAILS)
0402.5.1.2.1	MATERIALS	MATERIALS	GYPSUM BOARD WITH A THICKNESS OF NOT LESS THAN 1/2 INCH MEET THE REQUIREMENTS OF SECTION C402.5.1.2.1.	ITEMS 1 THROUGH 16 LISTED IN THIS SECTION MUST COMPLY WITH THE REQUIREMENTS OF THIS SECTION.	A-300 (PARTITION DETAILS)
0402.5.1.2.2	ASSEMBLIES	ASSEMBLIES	CONCRETE MASONRY WALLS COATED WITH EITHER ONE APPLICATION OF BLOCK FILLER OR TWO APPLICATIONS OF A SEALER COATING MEET THE REQUIREMENTS OF C402.5.1.2.2, PROVIDED JOINTS ARE SEALED AND THE REQUIREMENTS OF SECTION C402.5.1.1 ARE MET.		A-300 (EXTERIOR WALL DETAIL)
2402.5.2, TABLE 2402.5.2	AIR LEAKAGE OF FENESTRATION	SWINGING ENTRANCE DOORS, FLOOR 1	SWINGING ENTRANCE DOORS = 0.20 CFM/SF OF DOOR AREA	MAX AIR LEAKAGE RATES: CURTAIN WALLS AND STOREFRONT GLAZING = 0.06 CFM/SF COMMERCIAL GLAZED SWINGING ENTRANCE DOORS AND REVOLVING DOORS = 1.0 CFM/SF OF DOOR AREA	A-002 (SEE AIR LEAKAGE NOTES)
C402.5.4	OPENINGS TO SHAFTS, CHUTES, STAIRWAYS, AND	DOORS FROM CORRIDORS TO STAIRWELLS	TO STAIRWAY TO BE	ACCESS OPENINGS FROM CONDITIONED SPACE TO SHAFTS, CHUTES, STAIRWAYS AND ELEVATOR LOBBIES SHALL MEET C402.5.2 OR BE GASKETED, WEATHERSTRIPPED, OR SEALED.	A-002, A-003 (SEE AIR LEAKAGE NOTES)
0402.5.5	AIR INTAKES, EXHAUST OPENINGS, STAIRWAYS AND SHAFTS	AIR INTAKES, EXHAUST OPENINGS, STAIRWAYS & SHAFTS REQUIREMENTS FOR DAMPERS	STAIRWAY ENCLOSURE AND SHAFTS DAMPERS AS REQUIRED.	DAMPERS MUST BE PROVIDED IN ACCORDANCE WITH SECTION C403.2.4.3.	A-002, A-003 (SEE AIR LEAKAGE NOTES)
C402.5.7	VESTIBULES	BUILDING ENTRANCE VESTIBULE	5' DEEP VESTIBULE @ BUILDING ENTRANCE. TWO SETS OF SWINGING DOORS WITH SELF-CLOSERS.	VESTIBULE PROVIDED AT DOOR SEPARATING CONDITIONED SPACE FROM THE EXTERIOR.	A-002 (1ST FLOOR PLAN)
C405.1	DWELLING UNIT LIGHTING	DWELLING UNIT LIGHTING FIXTURES	· · · · · · · · · · · · · · · · · · ·	75 PERCENT OF THE LAMPS IN PERMANENTLY INSTALLED LIGHTING FIXTURES, OR NOT LESS THAN 75 PERCENT OF THE PERMANENTLY INSTALLED LIGHTING FIXTURE, OTHER THAN LOW VOLTAGE LIGHTING, SHALL BE HIGH-EFFICACY LAMPS.	EN-003, EN-004 (SEE NOTE)
C405.2	LIGHTING CONTROLS (MANDATORY)	INTERIOR LIGHTING CONTROLS INCLUDE OCCUPANCY SENSORS, DAYLIGHT RESPONSIVE CONTROLS, BI-LEVEL CONTROLS, AND AUTOMATIC SHUT-OFF	OCCUPANCY SENSORS AT STAIRWELLS, RESTROOMS AND STORAGE ROOMS.	LIGHTING SYSTEMS SHALL BE PROVIDED WITH CONTROLS AS SPECIFIED IN SECTIONS C405.2.1, C405.2.2, C405.2.3, C405.2.4 AND C405.2.5. EXCEPTIONS: LIGHTING CONTROLS ARE NOT REQUIRED FOR THE FOLLOWING: 1. AREAS DESIGNATED AS SECURITY OR EMERGENCY AREAS THAT ARE REQUIRED TO BE CONTINUOUSLY LIGHTED. 2. INTERIOR EXIT STAIRWAYS, INTERIOR EXIT RAMPS & EXIT PASSAGEWAYS. 3. EMERGENCY EGRESS LIGHTING THAT IS NORMALLY OFF.	EN-003, EN-004 (SEE NOTE)
C405.2.1	OCCUPANT SENSOR CONTROLS	IN EACH RESTROOM, STORAGE AREA, AND STAIRWELL	OCCUPANCY AND VACANCY SENSORS PROVIDED WITH 20 MINUTE SHUT OFF LIMIT	C405.2.1 SHALL COMPLY WITH THE FOLLOWING: 1. AUTOMATICALLY TURN OFF LIGHTS WITHIN 20 MINUTES OF ALL OCCUPANTS LEAVING THE SPACE. 2. BE MANUAL ON OR CONTROLLED TO AUTOMATICALLY TURN THE LIGHTING ON TO NOT MORE THAN 50 PERCENT POWER.	EN-003, EN-004 (SEE NOTE)
C405.2.5	EXTERIOR LIGHTING CONTROLS	EXTERIOR LIGHTING CONTROLS	LIGHTING ON THE FRONT & REAR FACADES SHALL HAVE CONTROLS THAT AUTOMATICALLY SHUT OFF THE LIGHTING AS A FUNCTION OF DAWN/DUSK & A SET OPEN & CLOSE TIME		EN-003, EN-004 (SEE NOTE)
C405.3	EXIT SIGNS	EIGHT NEW LED EXIT SIGNS TO BE PROVIDED	5W PER SIDE	INTERNALLY ILLUMINATED EXIT SIGNS SHALL NOT EXCEED 5 WATTS PER SIDE.	EN-003, EN-004 (REFLECTED CEILING PLANS)
2405.4	INTERIOR LIGHTING POWER REQUIREMENTS	INTERIOR LIGHTING POWER REQUIREMENTS	LPD VALUE FOR BUILDING IS LESS THAN THE INTERIOR LIGHTING POWER CALCULATED UNDER SECTION C405.4.2.	SHALL BE DETERMINED IN ACCORDANCE WITH	EN-004 (INTERIOR LIGHTING AND POWER CALCULATION SCHEDULE)
C405.5	EXTERIOR LIGHTING (MANDATORY)		THE TOTAL EXT. LIGHTING POWER IS LESS THAN THE EXT. LIGHTING POWER AS PER SECTION C405.5.	THE EXTERIOR LIGHTING POWER ALLOWANCE SHALL BE DETERMINED IN ACCORDANCE WITH SECTION C405.5.1.	EN-004 (EXTERIOR LIGHTING AND POWER CALCULATION EXAMPLE)
0405.6	ELECTRICAL ENERGY CONSUMPTION (MANDATORY)			EACH DWELLING UNIT LOCATED IN GROUP R-2 BUILDING SHALL HAVE A SEPARATE ELECTRICAL METER.	EN-003 (CELLAR REFLECTED CEILING PLAN)
C405.8		ELECTRICAL MOTORS	ELECTRIC MOTORS ARE IN COMPLIANCE AS PER C405.8.	ELECTRIC MOTORS SHALL MEET THE MINIMUM EFFICIENCY REQUIREMENTS OF TABLES C405.8(L) THROUGH C405.8(4) WHEN TESTED AND RATED IN ACCORDANCE WITH THE DOE 10 CFR 431. THE EFFICIENCY SHALL BE VERIFIED THROUGH	
				PROGRAM OR, WHERE A CERTIFICATION PROGRAM DOES NOT EXIST, THE EQUIPMENT EFFICIENCY RATINGS SHALL BE SUPPORTED BY DATA FURNISHED BY THE MOTOR MANUFACTURER.	And the second s

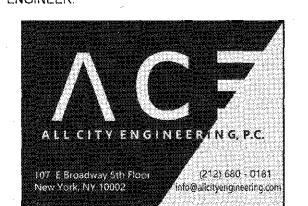
PROJECT NAME:

178 MOTT STREET **NEW YORK, NY 10012** OFFICE CONVERSION

DESIGN ENGINEER:



MEP ENGINEER:



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REV#:	DATE	DESCRIPTION:

INFORMATION SHOWN ON THE DRAWING.

DRAWING TITLE:

ENERGY ANALYSIS

PROJ. #: MW 618

SCALE: AS SHOWN DRAWING DATE: 06/26/2019

DRAWN BY: JL PROFESSIONAL SEAL



DWG.#

EN-001.00

DOB BARCODE

DEPT BLDGS Job No. 123819305 Scan Code ESHS1540961

SHEET 6 OF 30

LEGEND

EXISTING WALL TO REMAIN

PROPERTY LINE

EXISTING WALL TO REMOVE

EXISTING STORAGE TO REMAIN,
PLAN FOR REFERENCE.
(NO | DEMOLITION WORK PROPOSED) EXISTING EXISTING CONCRETE CONCRETE B --- 05 ÉXISTING EARTH/SOIL INSTALL NEW S.O.G SEE DWG A-101 MOTT STREET

> SUB-CELLAR EXISTING PLAN SCALE:1/8"=1'-0"

NOTE: THERE IS NO HVAC, PLUMBING AND SPRINKLER DEMOLITION WORK. FOR HVAC, PLUMBING AND SPRINKLER PROPOSED WORK, SEE MEP DWG.

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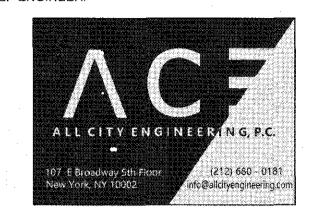
PROJECT NAME:

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REV #: DATE DESCRIPTION:

DRAWING TITLE:

SUB-CELLAR **EXISTING PLAN**

PROJ. #: MW 618

SCALE: AS SHOWN

DRAWING DATE: 06/26/2019

DRAWN BY: JL

CHECKED BY: MW PROFESSIONAL SEAL:

DWG.#

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DOB BARCODE



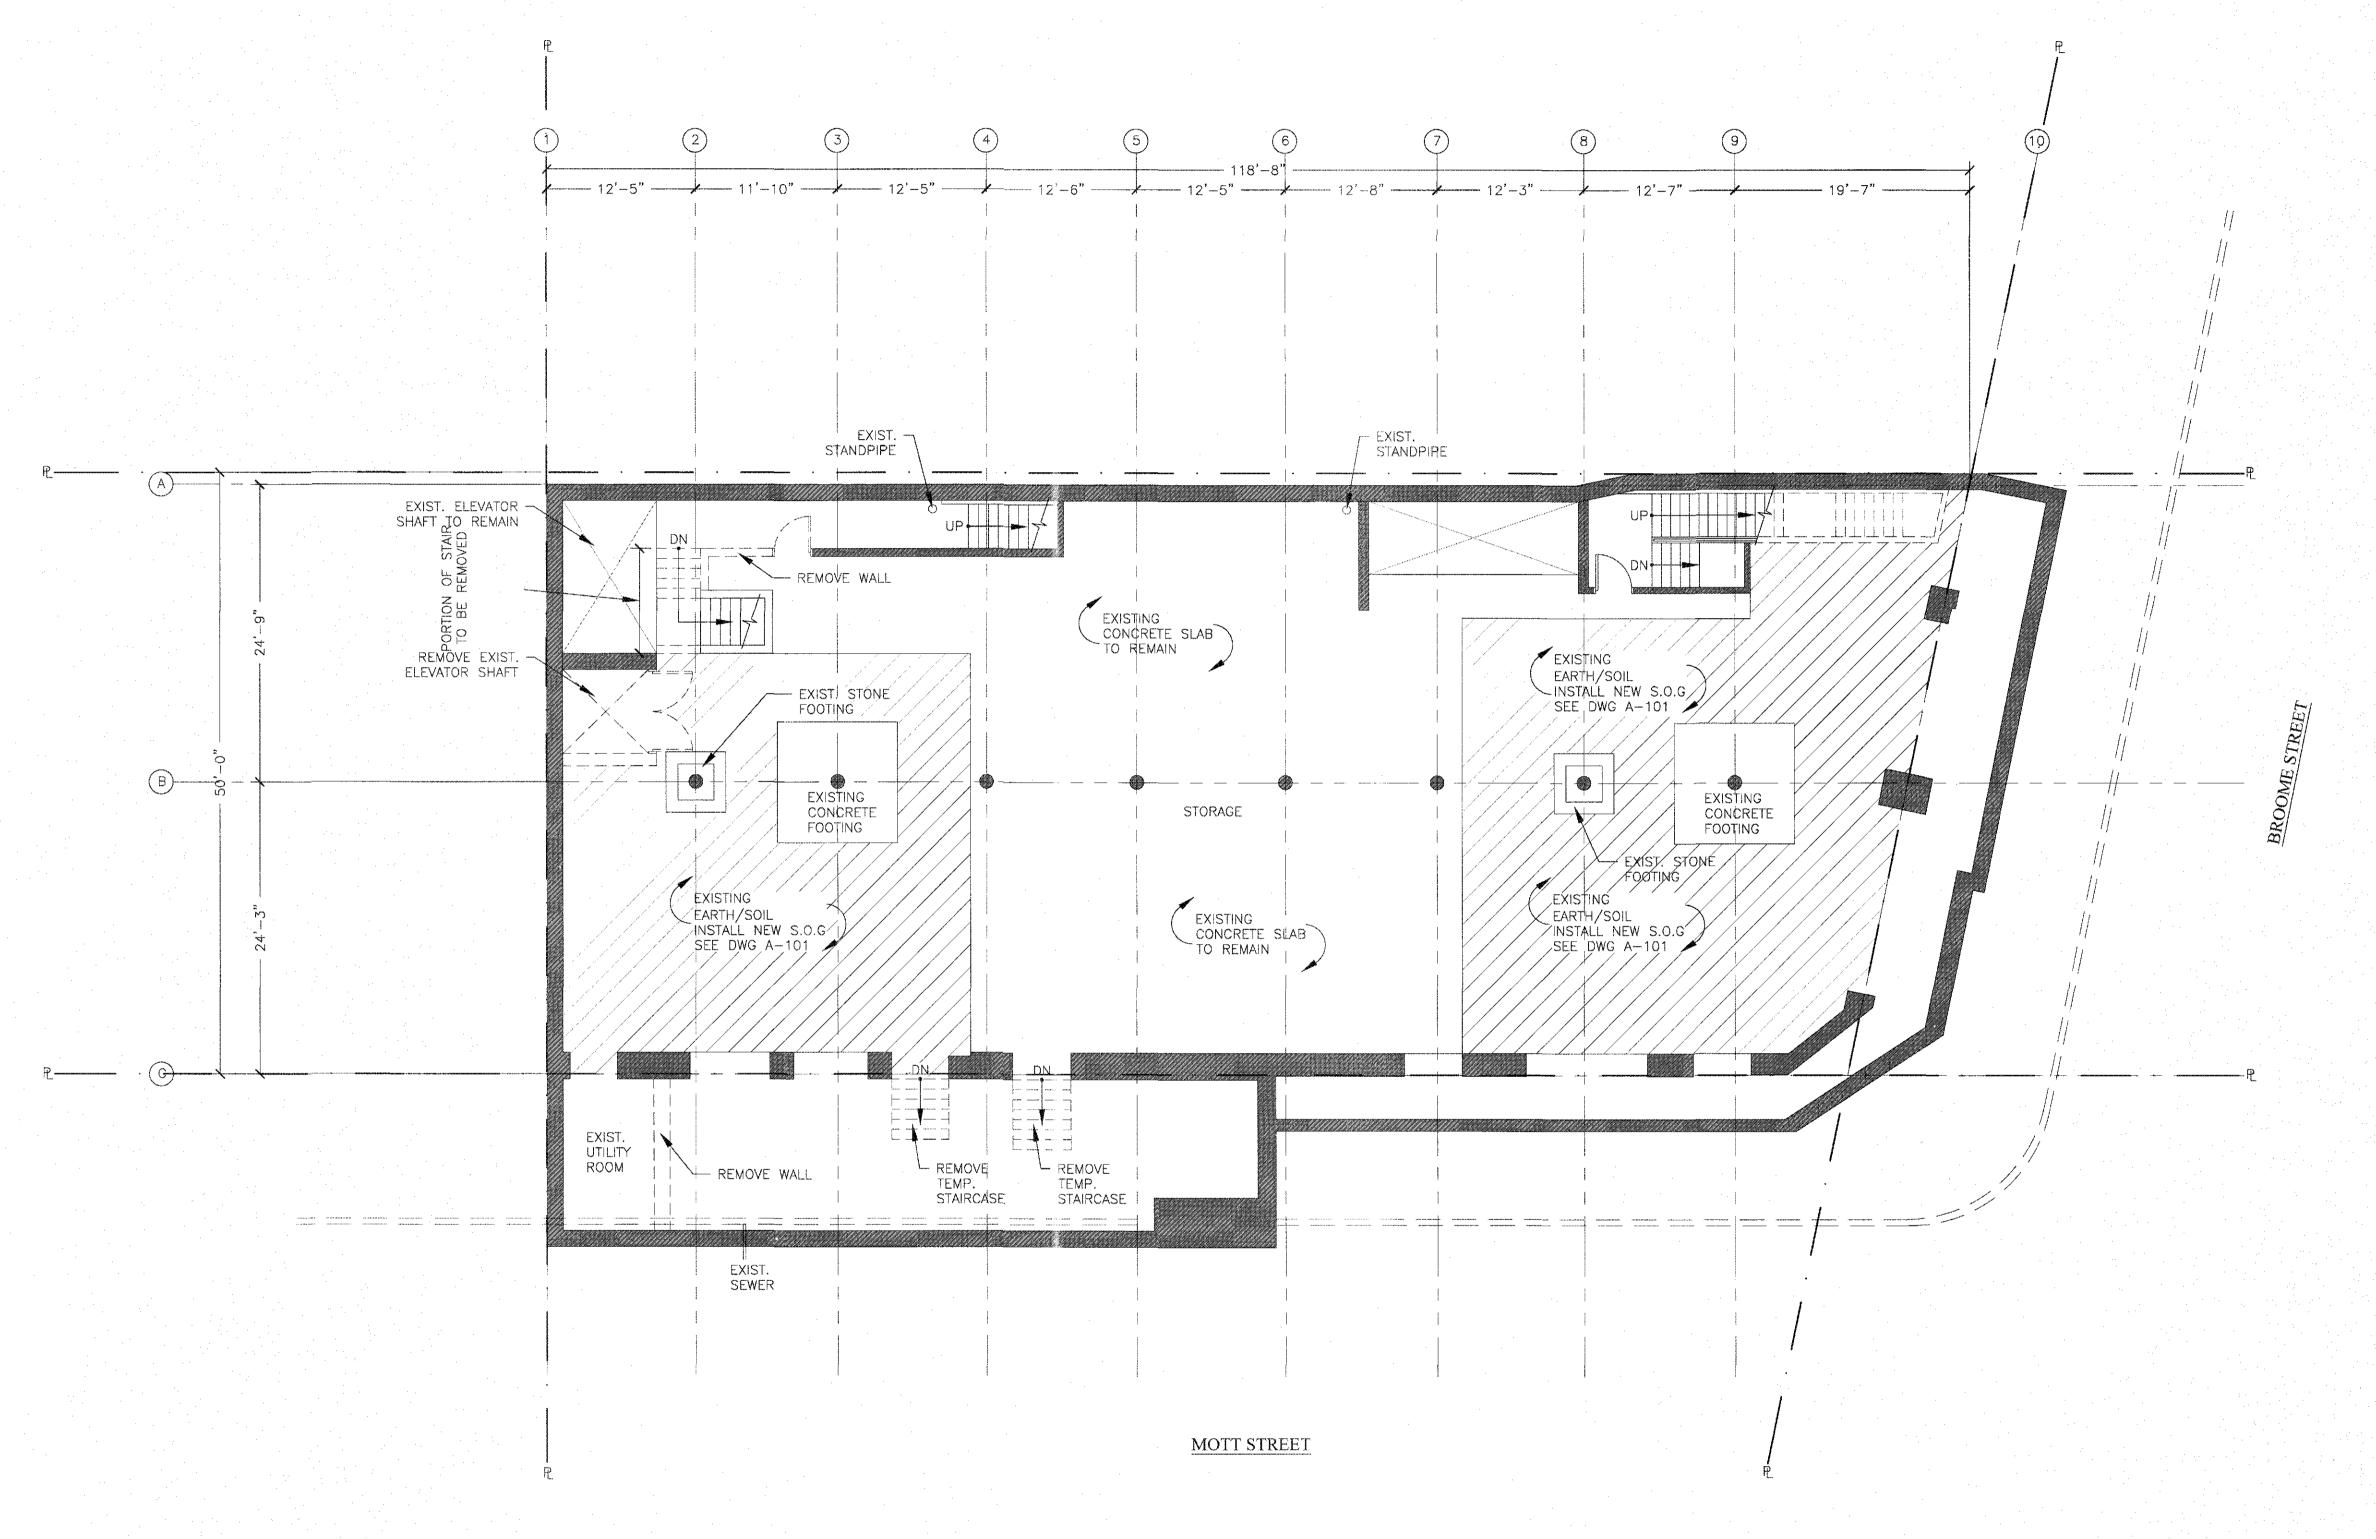
SHEET 7 OF 30

<u>LEGEND</u>

EXISTING WALL TO REMAIN

PROPERTY LINE

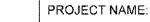
____ EXISTING WALL TO REMOVE



CELLAR DEMO PLAN

SCALE:1/8"=1'-0"

NOTE: THERE IS NO HVAC, PLUMBING AND SPRINKLER DEMOLITION WORK FOR HVAC, PLUMBING AND SPRINKLER PROPOSED WORK, SEE MEP DWG.

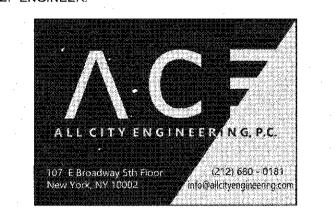


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REV#: DATE DESCRIPTION:

DRAWING TITLE:

CELLAR DEMOLITION PLAN

PROJ. #: MW 618

SCALE: AS SHOWN

DRAWING DATE: 06/26/2019

DRAWN BY: JL CHECKED BY: MW

PROFESSIONAL SEAL:



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DOB BARCODE

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DEPT BLDGS Job No. 123819305
Scan Code ESHS6473511

SHEET 8 OF 30

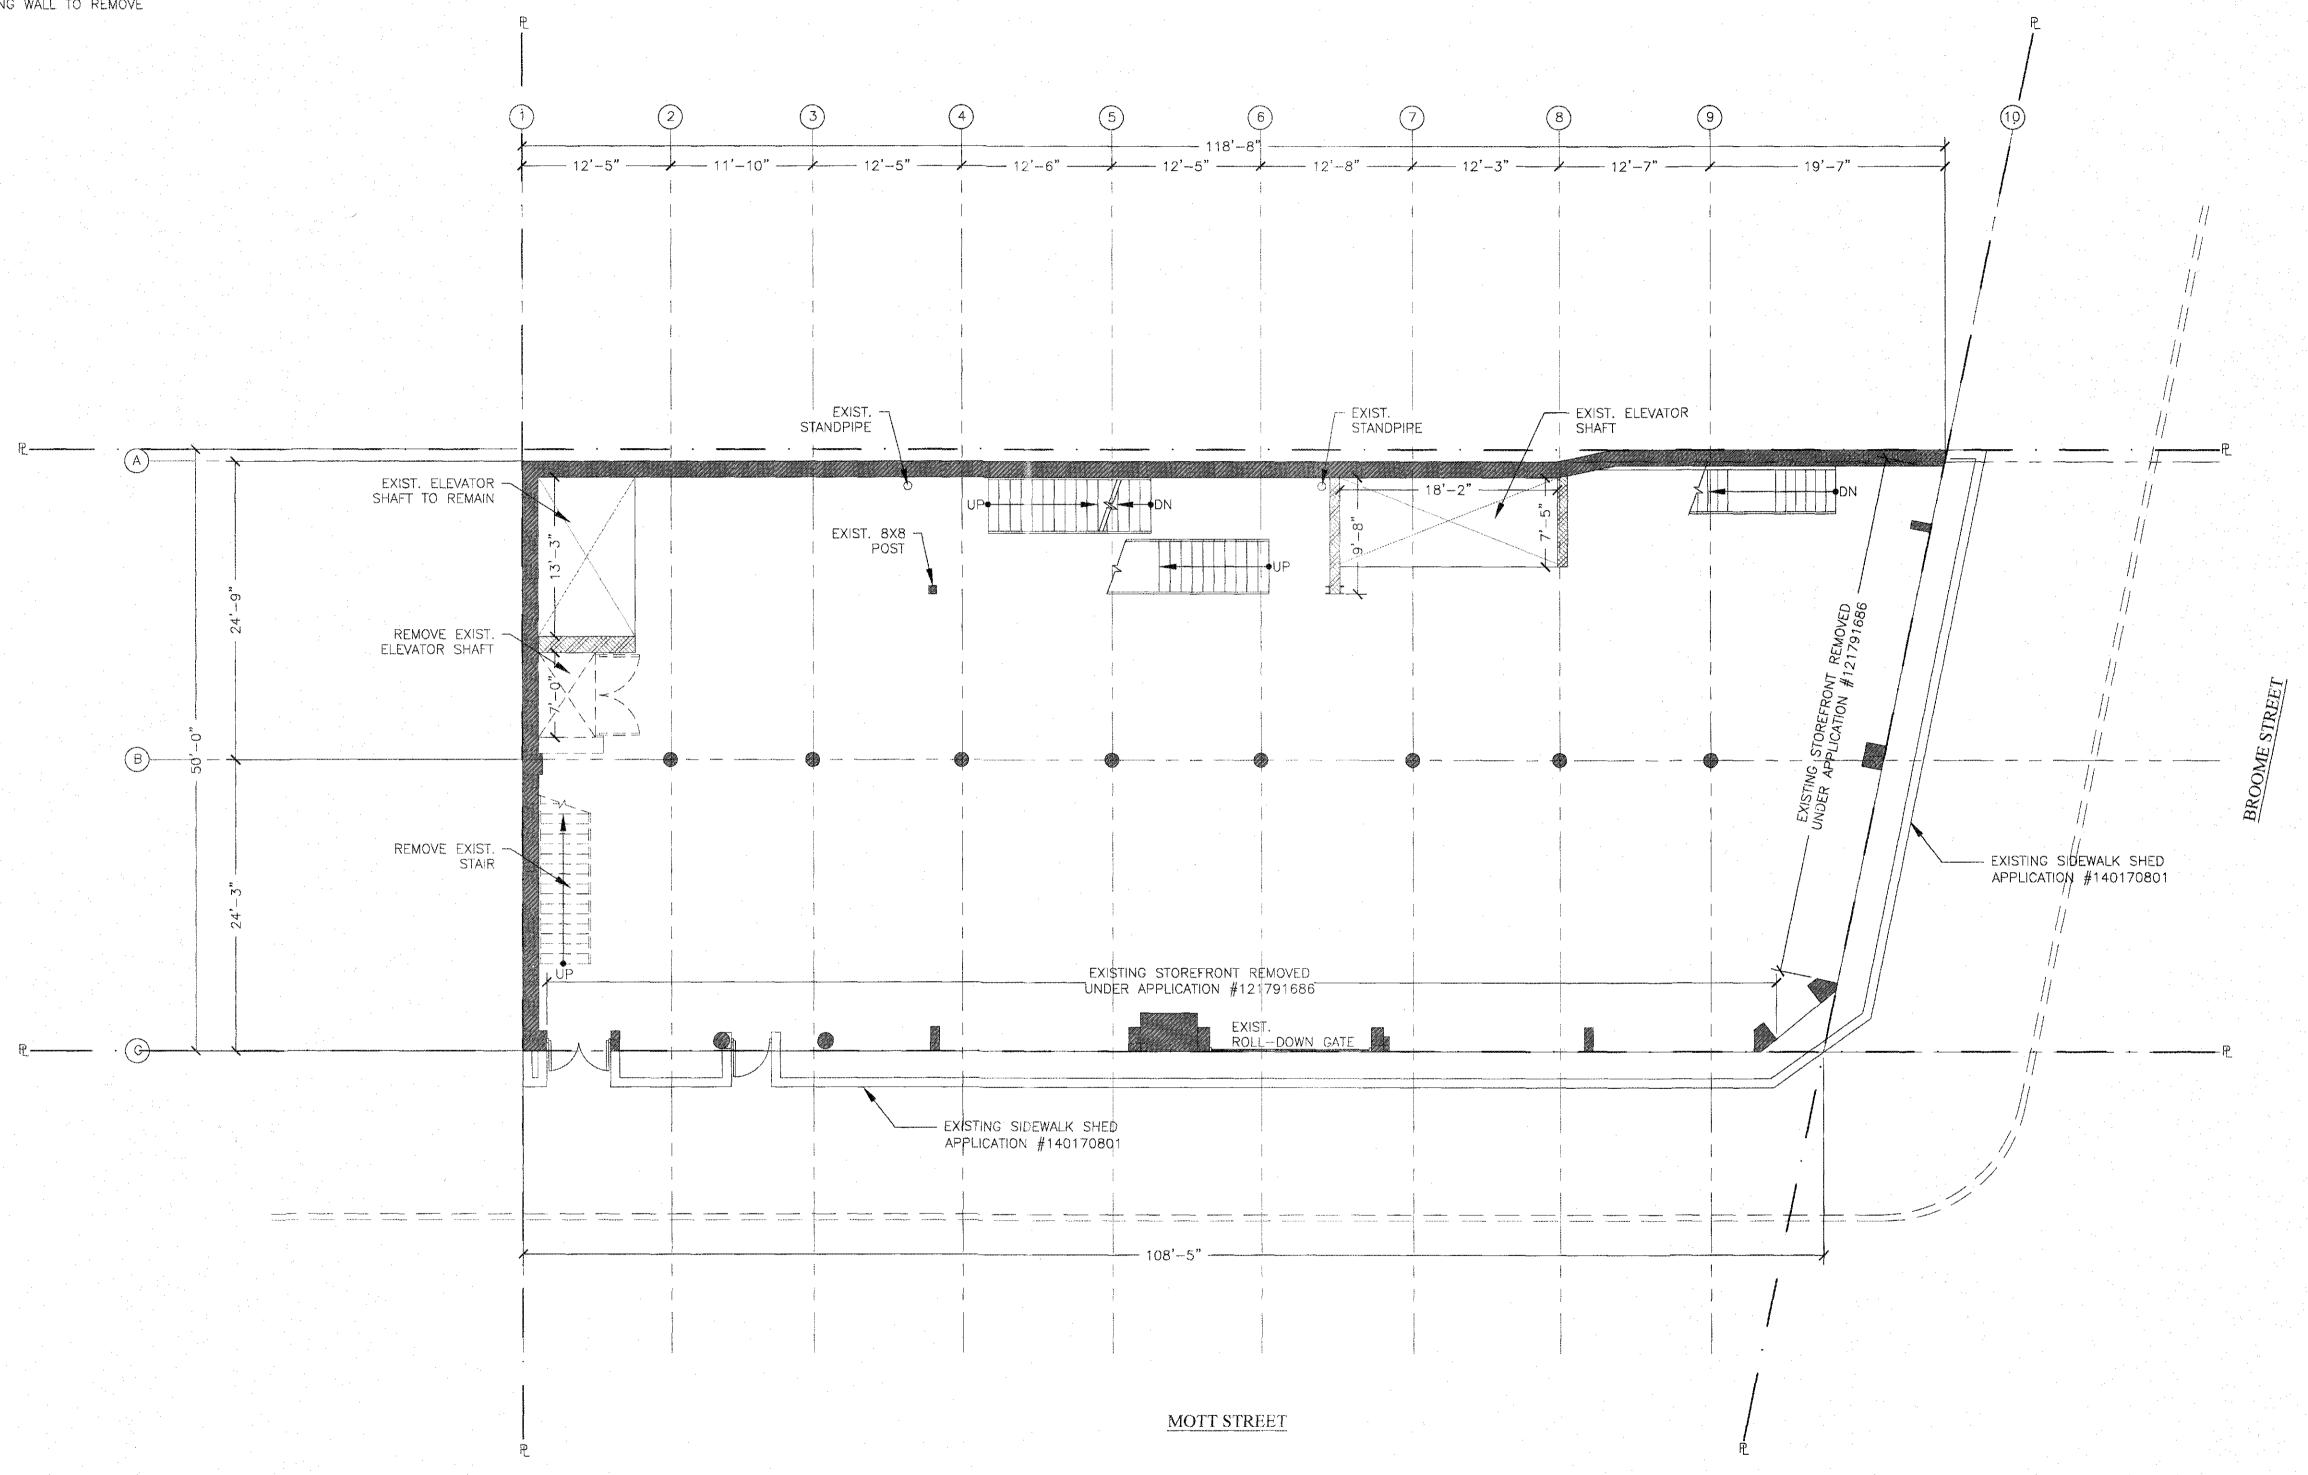
LEGEND

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EXISTING TEMPORARY CONSTRUCTION FENCE

PROPERTY LINE

EXISTING WALL TO REMOVE



1ST FLOOR DEMO PLAN SCALE:1/8"=1'-0"

THERE IS NO HVAC, PLUMBING AND SPRINKLER DEMOLITION WORK. FOR HVAC, PLUMBING AND SPRINKLER PROPOSED WORK, SEE MEP DWG.

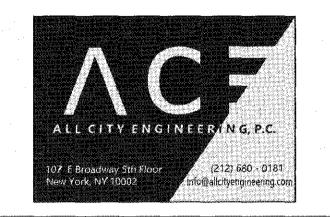
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DRAWING TITLE:

1ST FLOOR DEMOLITION PLAN

PROJ. #: MW 618

SCALE: AS SHOWN

DRAWING DATE: 06/26/2019

CHECKED BY: MW DRAWN BY: JL



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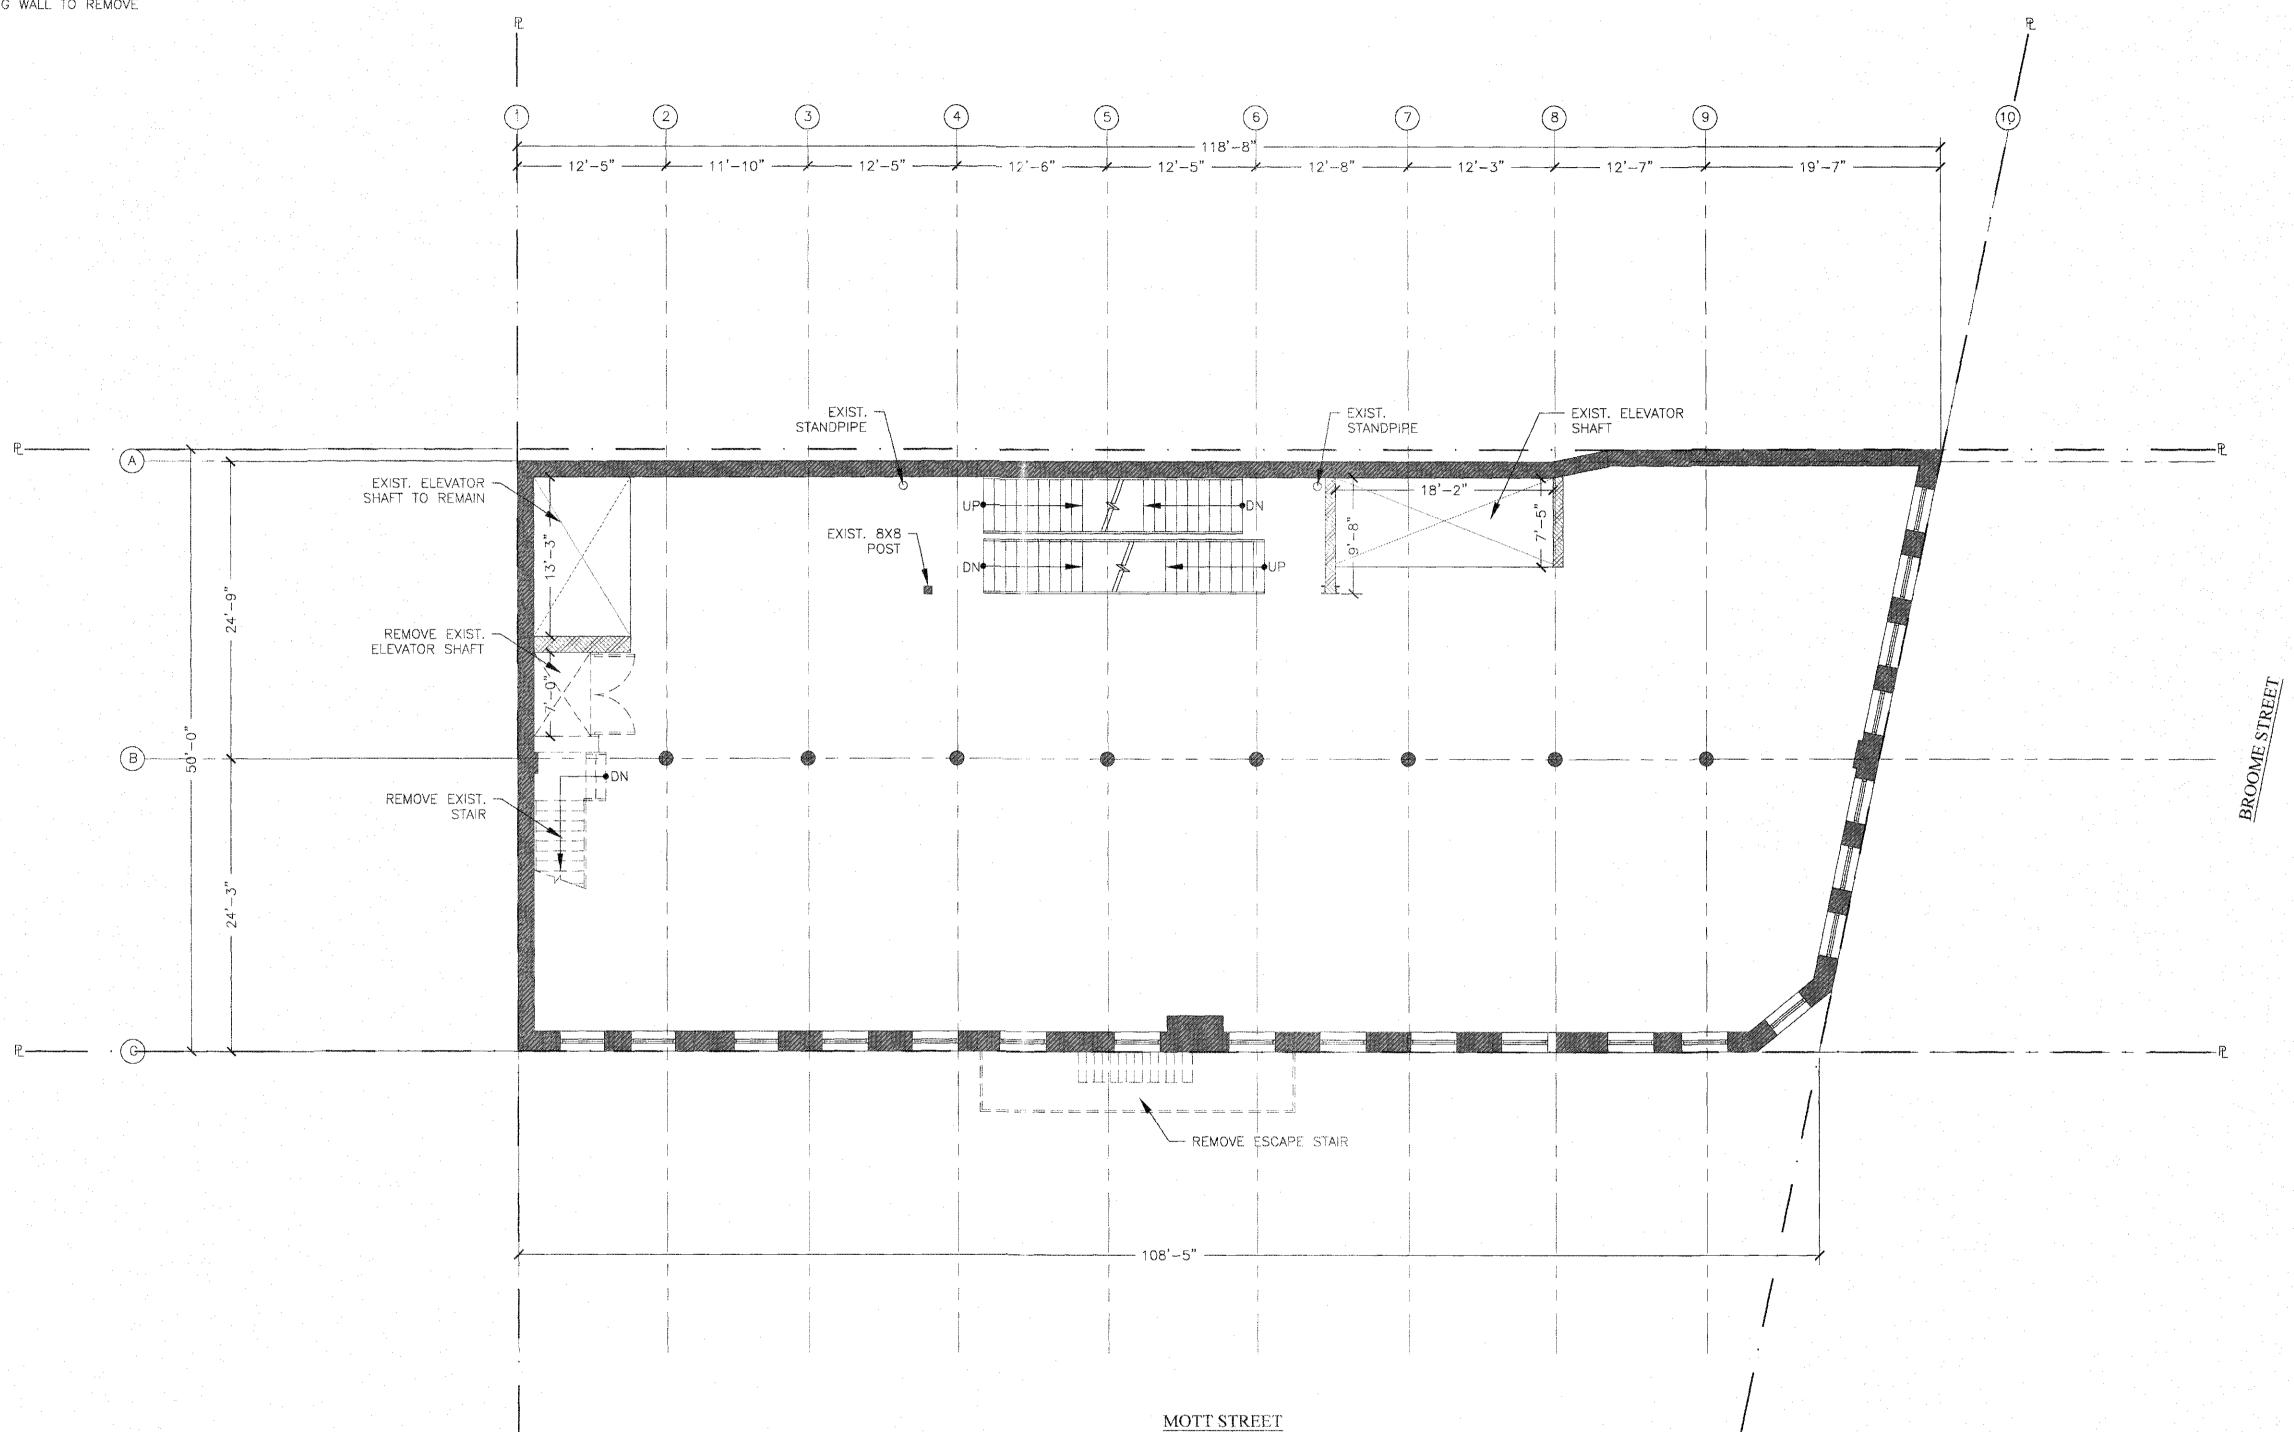
LEGEND

EXISTING WALL TO REMAIN

EXISTING TEMPORARY CONSTRUCTION FENCE

PROPERTY LINE

EXISTING WALL TO REMOVE



2ND FLOOR DEMO PLAN SCALE:1/8"=1'-0"

NOTE: THERE IS NO HVAC, PLUMBING AND SPRINKLER DEMOLITION WORK. FOR HVAC, PLUMBING AND SPRINKLER PROPOSED WORK, SEE MEP DWG.



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DEPT BLDGS Job No. 123819305 Scan Code ESHS0670892

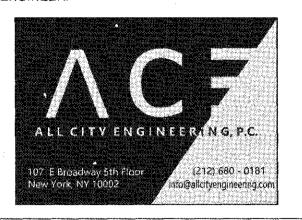
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REV#: DATE DESCRIPTION:

DRAWING TITLE:

2ND FLOOR DEMOLITION PLAN

PROJ. #: MW 618

SCALE: AS SHOWN

DRAWING DATE: 06/26/2019

DRAWN BY: JL

CHECKED BY: MW PROFESSIONAL SEAL:

DWG.# D-103.00

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SHAFT EXIST. |
STANDPIRE EXIST. STANDPIPE EXIST. ELEVATOR — SHAFT TO REMAIN EXIST. 8X8 7 REMOVE EXIST. -ELEVATOR SHAFT P O REMOVE ESCAPE STAIR MOTT STREET 3RD FLOOR DEMO PLAN SCALE:1/8"=1'-0" EXMENSED FOR ZONING BC 223 (20) PF FRAVILITION UNEY, AS FER DIFFE TO FEE THERE IS NO HVAC, PLUMBING AND SPRINKLER DEMOLITION WORK. FOR HVAC, PLUMBING AND SPRINKLER PROPOSED WORK, SEE MEP DWG.

PROJECT NAME:

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REV#: DATE DESCRIPTION:

DRAWING TITLE:

3RD FLOOR DEMOLITION PLAN

PROJ. #: MW 618

SCALE: AS SHOWN

DRAWING DATE: 06/26/2019

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Scan Code ESHS3761572

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<u>LEGEND</u> EXISTING WALL TO REMAIN EXISTING TEMPORARY CONSTRUCTION FENCE PROPERTY LINE EXISTING WALL TO REMOVE EXIST. T EXIST. ELEVATOR
SHAFT FEXIST. STANDPIRE EXIST. ELEVATOR -SHAFT TO REMAIN EXIST. 8X8 7 REMOVE EXIST. -ELEVATOR SHAFT - REMOVE ESCAPE STAIR MOTT STREET 4TH FLOOR DEMO PLAN SCALE:1/8"=1'-0"EXAMPLED FOR ZONING, ECONOMY AND FIRE PREVENTION ONLY, AS TO JULY 2 OF 1975 NOTE:
THERE IS NO HVAC, PLUMBING AND SPRINKLER DEMOLITION WORK. FOR HVAC,
PLUMBING AND SPRINKLER PROPOSED WORK, SEE MEP DWG.

PROJECT NAME:

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DESIGN ENGINEER:



MEP ENGINEER:



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REV#:	DATE	DESCRIPT	Ю

DRAWING TITLE:

4TH FLOOR DEMOLITION PLAN

PROJ. #: MW 618

SCALE: AS SHOWN

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DRAWING DATE: 06/26/2019

DRAWN BY: JL CHECKED BY: MW

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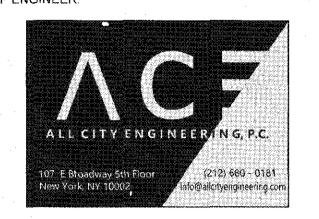
<u>LEGEND</u> EXISTING WALL TO REMAIN EXISTING TEMPORARY CONSTRUCTION FENCE ----- PROPERTY LINE EXISTING WALL TO REMOVE EXIST. -STANDPIPE - EXIST. STANDPIPE EXIST. ELEVATOR
SHAFT EXIST. ELEVATOR — SHAFT TO REMAIN EXIST. 8X8 7 REMOVE EXIST. — ELEVATOR SHAFT B ---- REMOVE ESCAPE STAIR MOTT STREET 5TH FLOOR DEMO PLAN SCALE:1/8"=1'-0" THERE IS NO HVAC, PLUMBING AND SPRINKLER DEMOLITION WORK, FOR HVAC, PLUMBING AND SPRINKLER PROPOSED WORK, SEE MEP DWG. PROJECT NAME:

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DESIGN ENGINEER:



MEP ENGINEER:



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REV#: DATE DESCRIPTION:

DRAWING TITLE:

5TH FLOOR DEMOLITION PLAN

PROJ. #: MW 618

SCALE: AS SHOWN

DRAWING DATE: 06/26/2019

DRAWN BY: JL CHECKED BY: MW

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DEPT BLDGS Job No. 123819305
Scan Code ESHS2084827

SHEET 13 OF 30

NEW YORK, NY 10012 OFFICE CONVERSION <u>LEGEND</u> EXISTING WALL TO REMAIN DESIGN ENGINEER: EXISTING TEMPORARY CONSTRUCTION FENCE PROPERTY LINE _____ EXISTING WALL TO REMOVE MEP ENGINEER: (212) 680 - 0181 info@allcrtyengineering.com 107 E Broadway 5th Floor New York, NY 10002 EXIST. ELEVATOR SHAFT EXIST. -EXIST. |
STANDPIPE EXIST. ELEVATOR -SHAFT TO REMAIN EXIST. 8X8 -\
POST \ REMOVE EXIST. — ELEVATOR SHAFT REMOVE EXIST. STAIR COPIED WITHOUT WRITTEN PERMISSION OF THE COMPANY.
THE COMPANY WILL NOT BE LIABLE FOR ANY DAMAGE OR
INJURY CAUSED BY UNAUTHORIZED USE OF THE
INFORMATION SHOWN ON THE DRAWING. - REMOVE ESCAPE STAIR DRAWING TITLE: 6TH FLOOR DEMOLITION PLAN MOTT STREET DRAWING DATE: 06/26/2019 CHECKED BY: MW DRAWN BY: JL PROFESSIONAL SEAL: 6TH FLOOR DEMO PLAN NOTE: THERE IS NO HVAC, PLUMBING AND SPRINKLER DEMOLITION WORK. FOR HVAC, PLUMBING AND SPRINKLER PROPOSED WORK, SEE MEP DWG. EXAMINED FOR ZONING, EGRESS AND FIRE PREVENTION ONLY AS A STOPPING, 2 OF 1975 DWG.# KENNETH FLADEN, RA. DOB BARCODE

PROJECT NAME:

178 MOTT STREET

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PROJ. #:	MW 618
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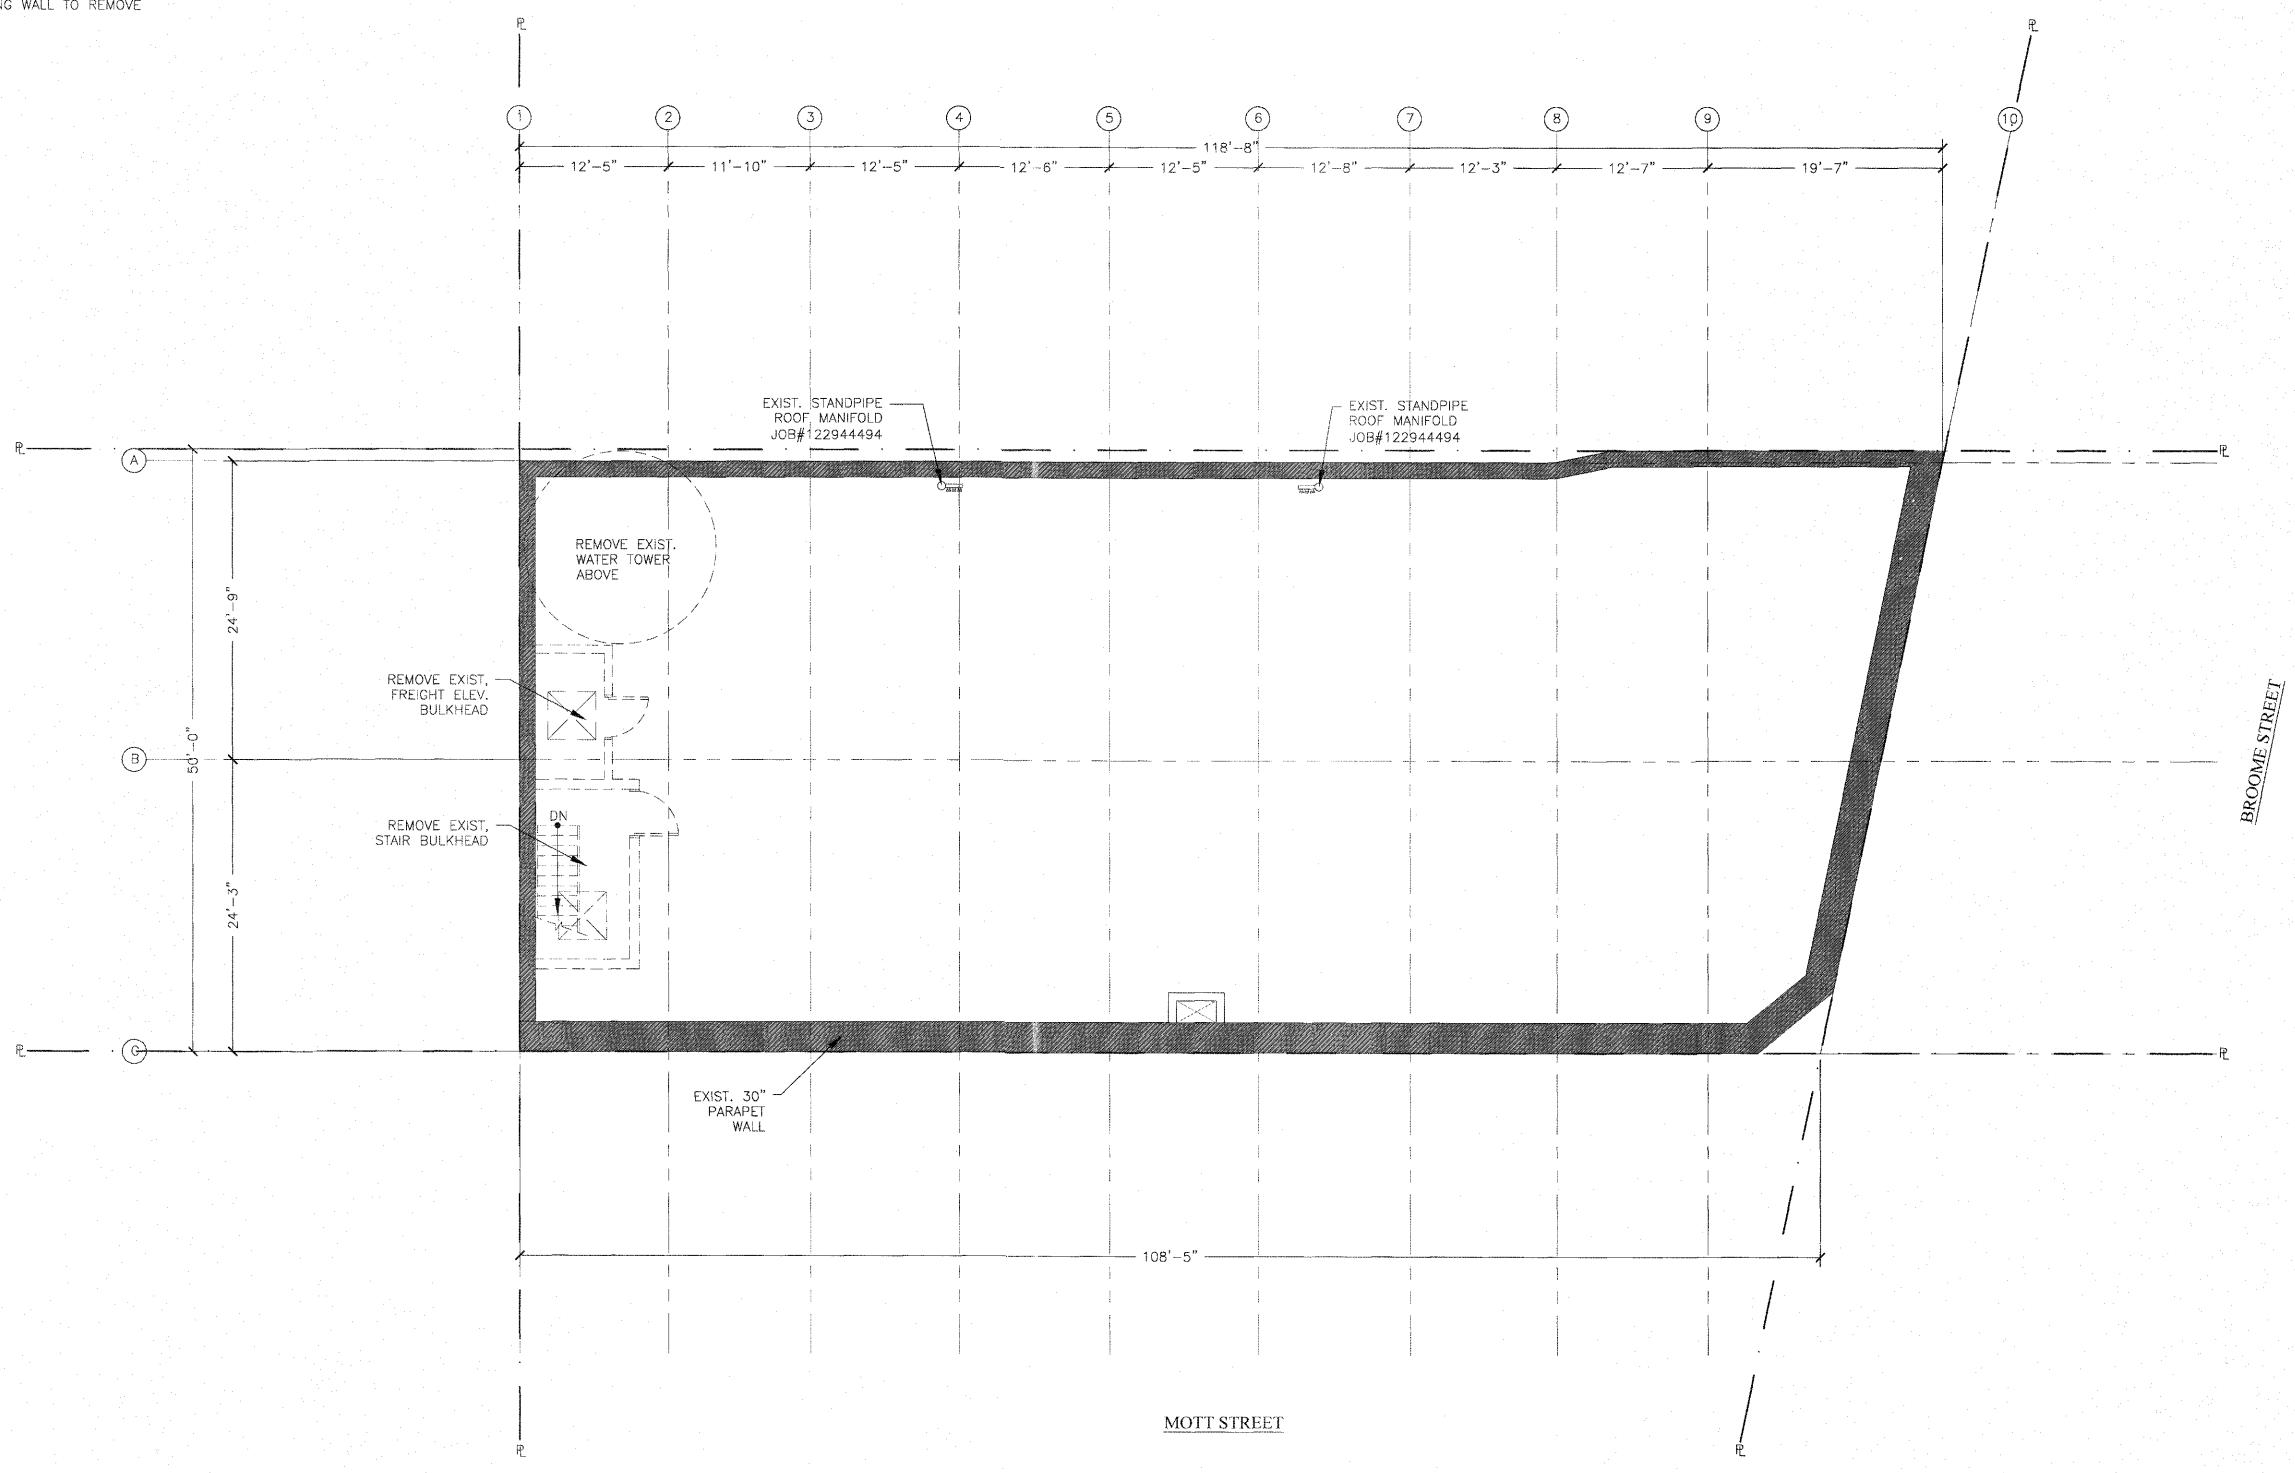
<u>LEGEND</u>

EXISTING WALL TO REMAIN

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----- PROPERTY LINE

EXISTING WALL TO REMOVE



ROOF DEMO PLAN SCALE:1/8"=1'-0"

THERE IS NO HVAC, PLUMBING AND SPRINKLER DEMOLITION WORK. FOR HVAC, PLUMBING AND SPRINKLER PROPOSED WORK, SEE MEP DWG.

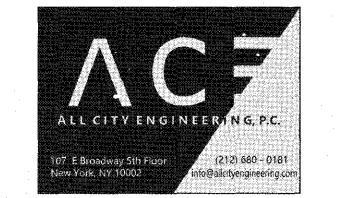
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REV#: DATE DESCRIPTION:

DRAWING TITLE:

ROOF DEMOLITION PLAN

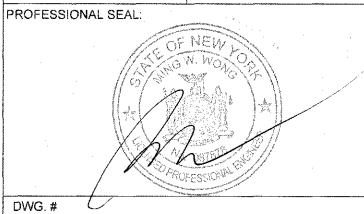
PROJ. #: MW 618

SCALE: AS SHOWN

DRAWING DATE: 06/26/2019

CHECKED BY: MW DRAWN BY: JL

PROFESSIONAL SEAL:



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EXISTING WALL TO REMAIN PROPERTY LINE NEW 2-HR FIRE RATED PARTITION TRAVEL DISTANCE (FT) EXIT BACKUP AND 3 HEAD EMERGENCY LIGHT STAIR C STAIR E - STEP FOR EXIST. FOUNDATION PROPOSED STORAGE/MECH F.A. 1117 SF PROPOSED PEOPLE == 10 B 000 STORAGE AND NEW S.O.G SEE STRUCT. DWG MOTT STREET

> PROPOSED SUB-CELLAR PLAN SCALE:1/8"=1'-0"

LEGEND

NOTE: THERE IS NO HVAC, PLUMBING AND SPRINKLER WORK SHOWN ON THIS PAGE. FOR HVAC, PLUMBING AND SPRINKLER PROPOSED WORK, SEE MEP DWG.

PROJECT NAME:

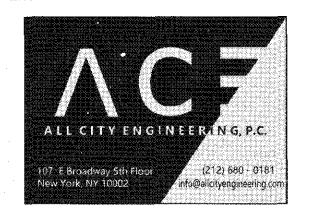
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DESIGN ENGINEER:



MW Professional Engineering, P.C.
CONSULTING ENGINEERS

MEP ENGINEER:



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REV#:	DATE	DESCRIPTION:	
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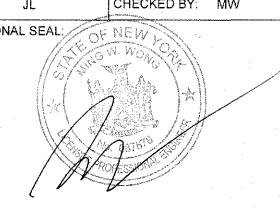
PROPOSED SUB-CELLAR PLAN

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PROJ. #:	MW 618	
SCALE:	AS SHOWN	

DRAWING DATE: 06/26/2019

CHECKED BY: MW

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DEPT BLDGS Job No. 123819305
Scan Code ESHS2647813

SHEET 16 OF 30

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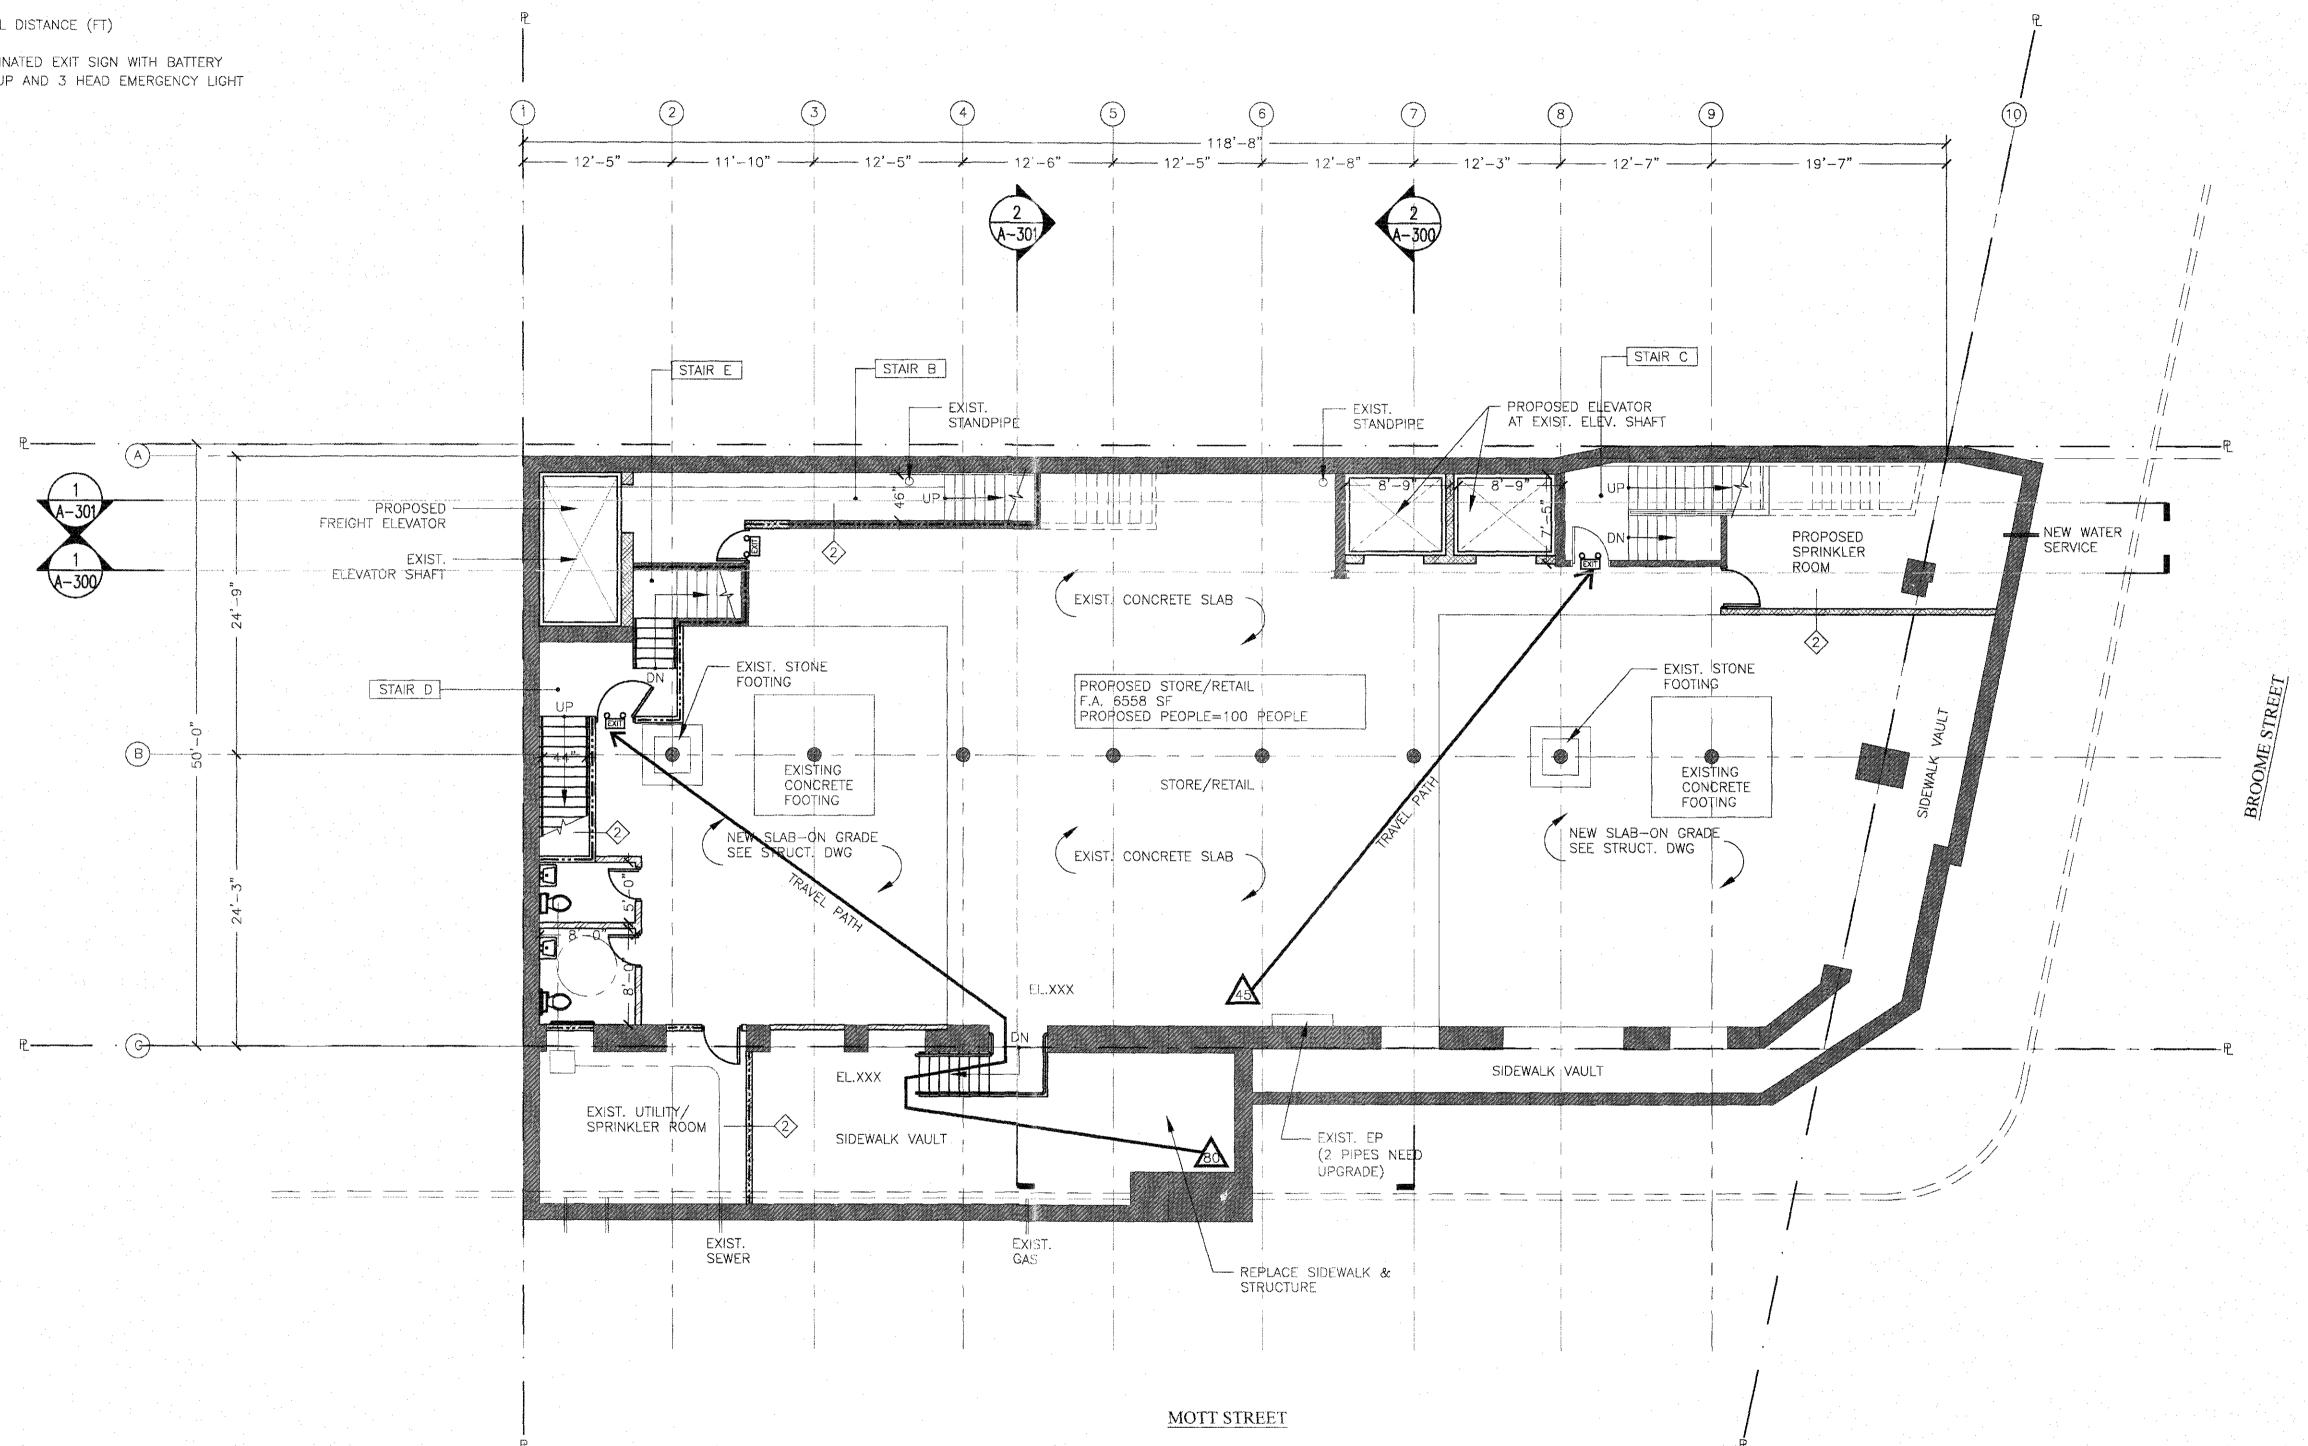
EXISTING WALL TO REMAIN

---- PROPERTY LINE

NEW 2-HR FIRE RATED PARTITION

TRAVEL DISTANCE (FT)

ILLUMINATED EXIT SIGN WITH BATTERY
BACKUP AND 3 HEAD EMERGENCY LIGHT



PROPOSED CELLAR PLAN SCALE:1/8"=1'-0"

THERE IS NO HVAC, PLUMBING AND SPRINKLER WORK SHOWN ON THIS PAGE. FOR HVAC, PLUMBING AND SPRINKLER PROPOSED WORK, SEE MEP DWG.

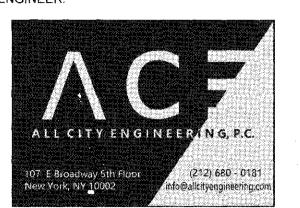
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PROPOSED CELLAR PLAN

PROJ. #: MW 618 SCALE: AS SHOWN DRAWING DATE: 06/26/2019

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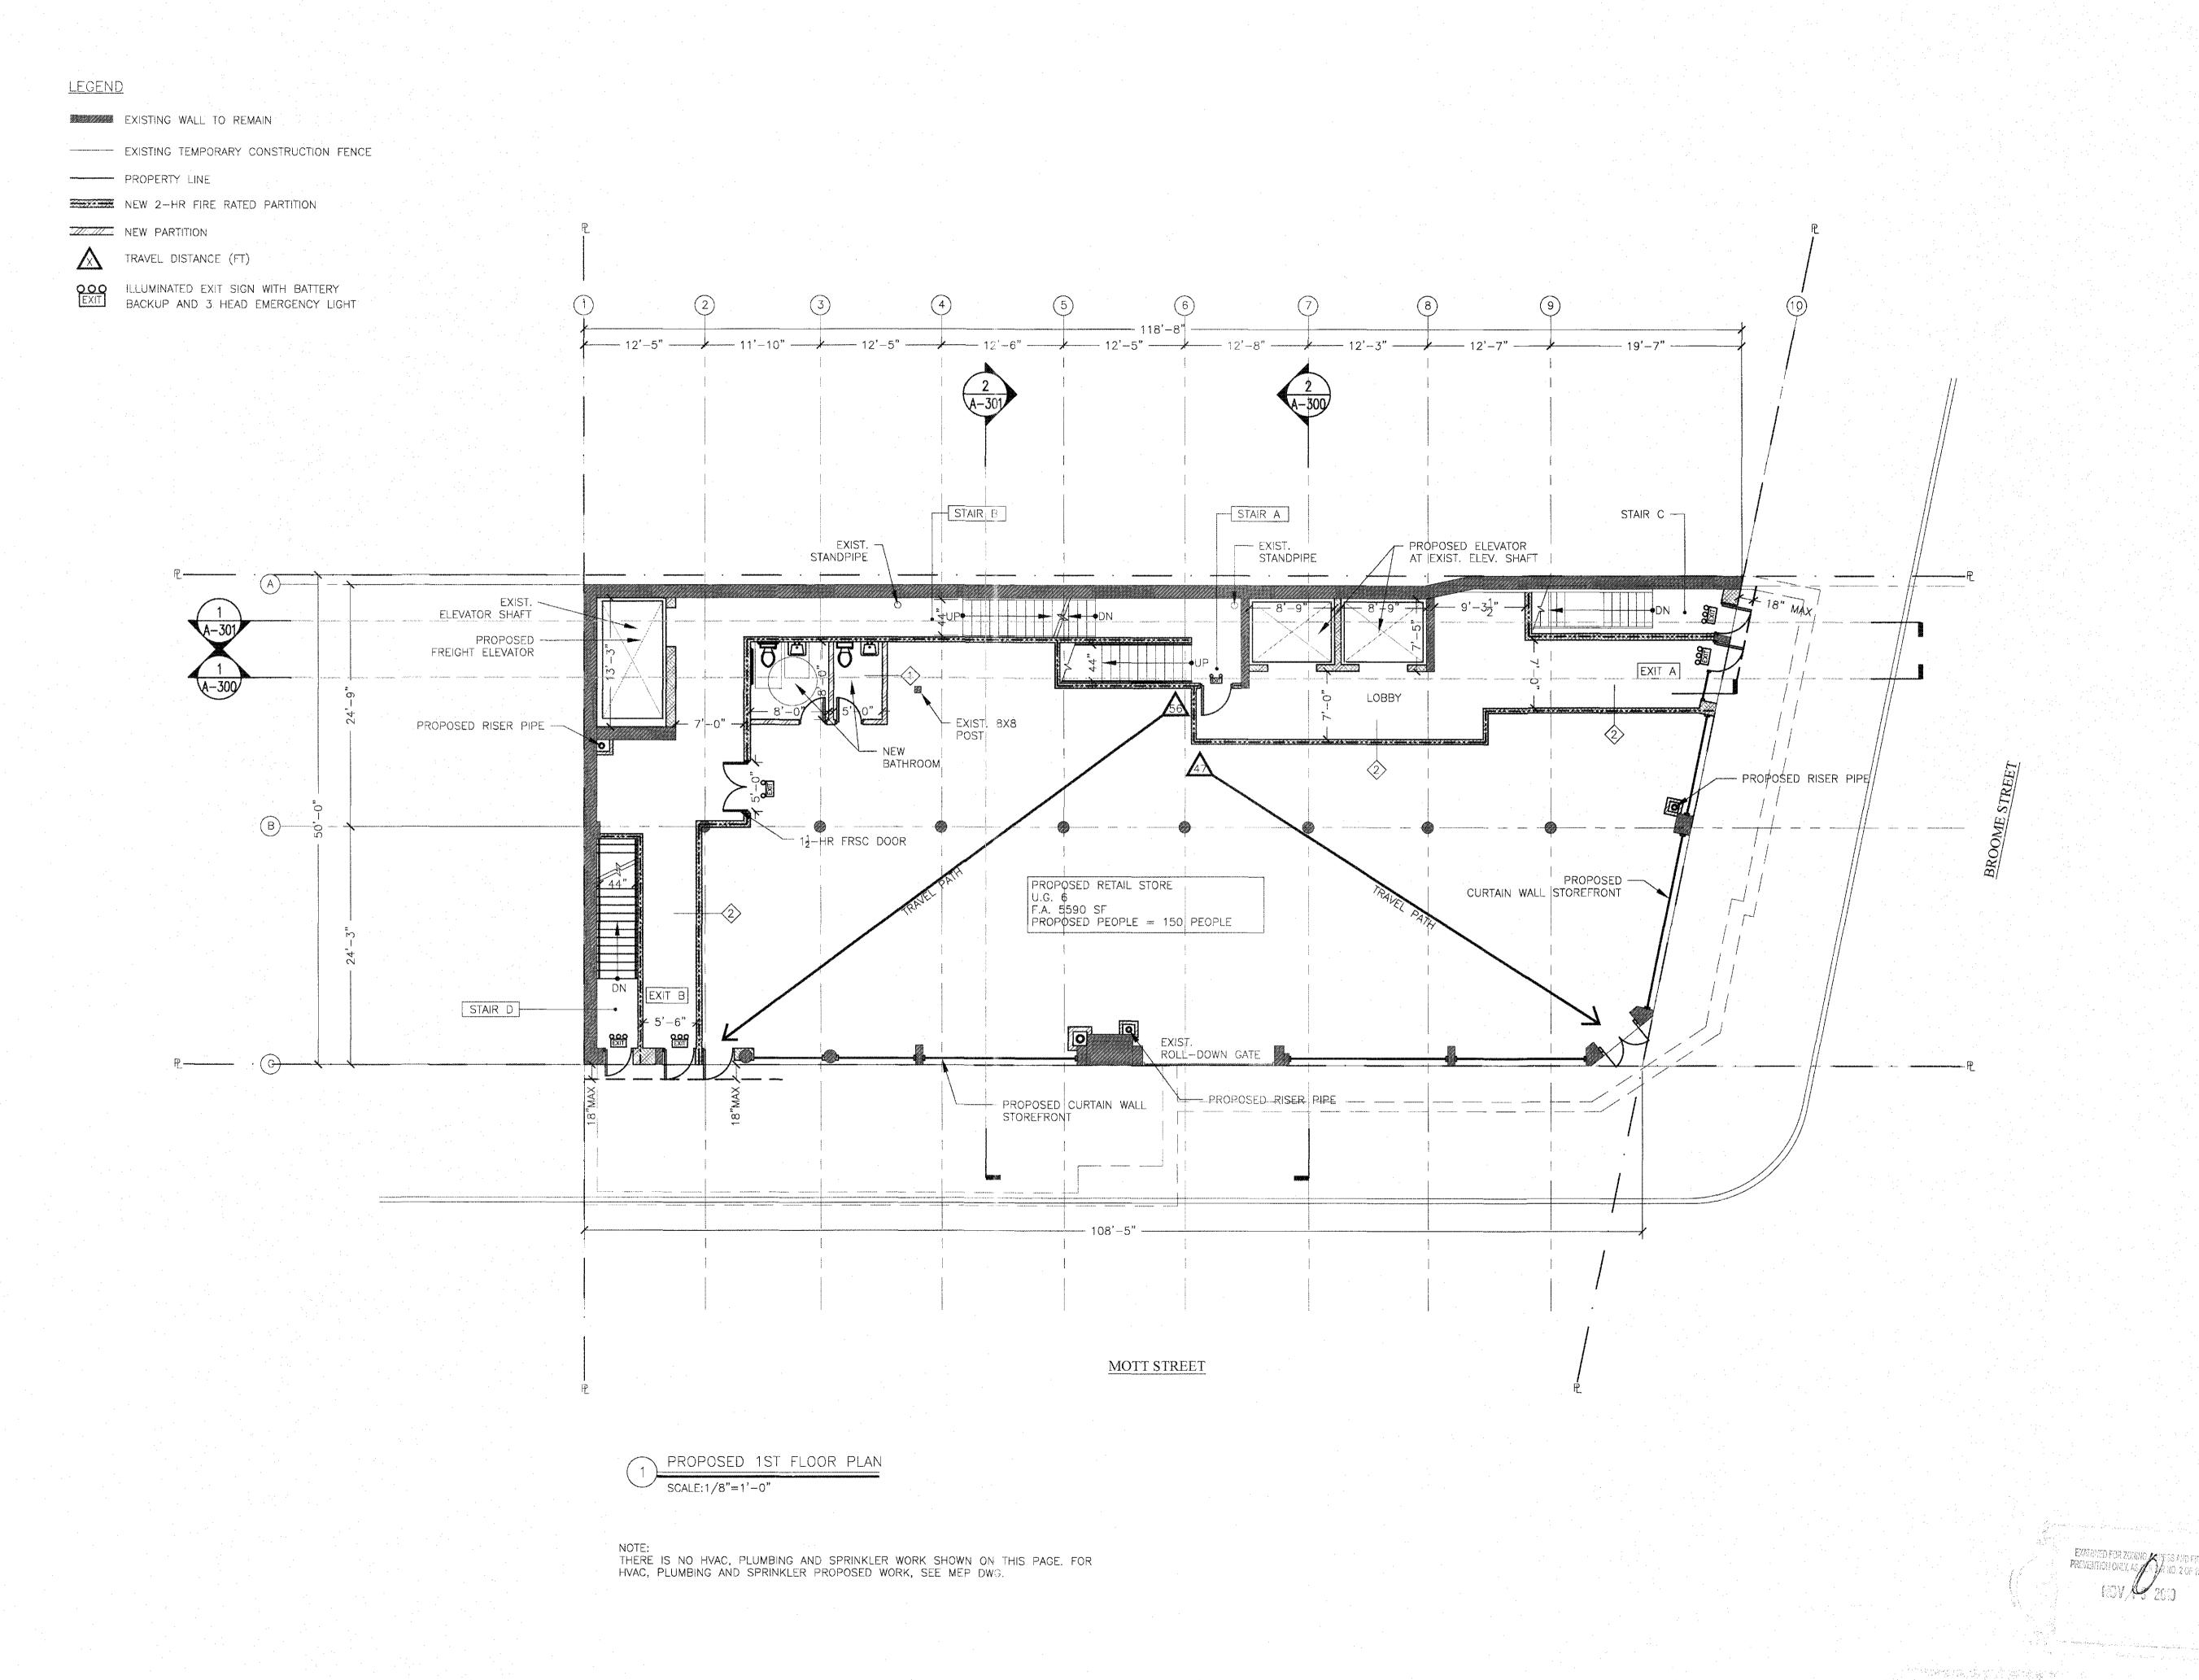
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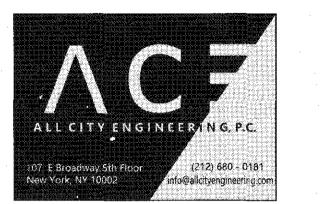
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DESIGN ENGINEER:



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CONSULTING ENGINEERS

MEP ENGINEER:



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REV #: DATE DESCRIPTION:

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PROJ. #: MW 618

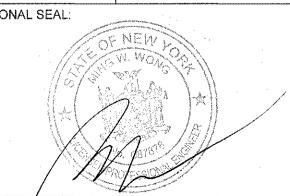
DRAWING TITLE:

SCALE: AS SHOWN

DRAWING DATE: 06/26/2019

CHECKED BY: MW DRAWN BY: JL

PROFESSIONAL SEAL:



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DOB BARCODE

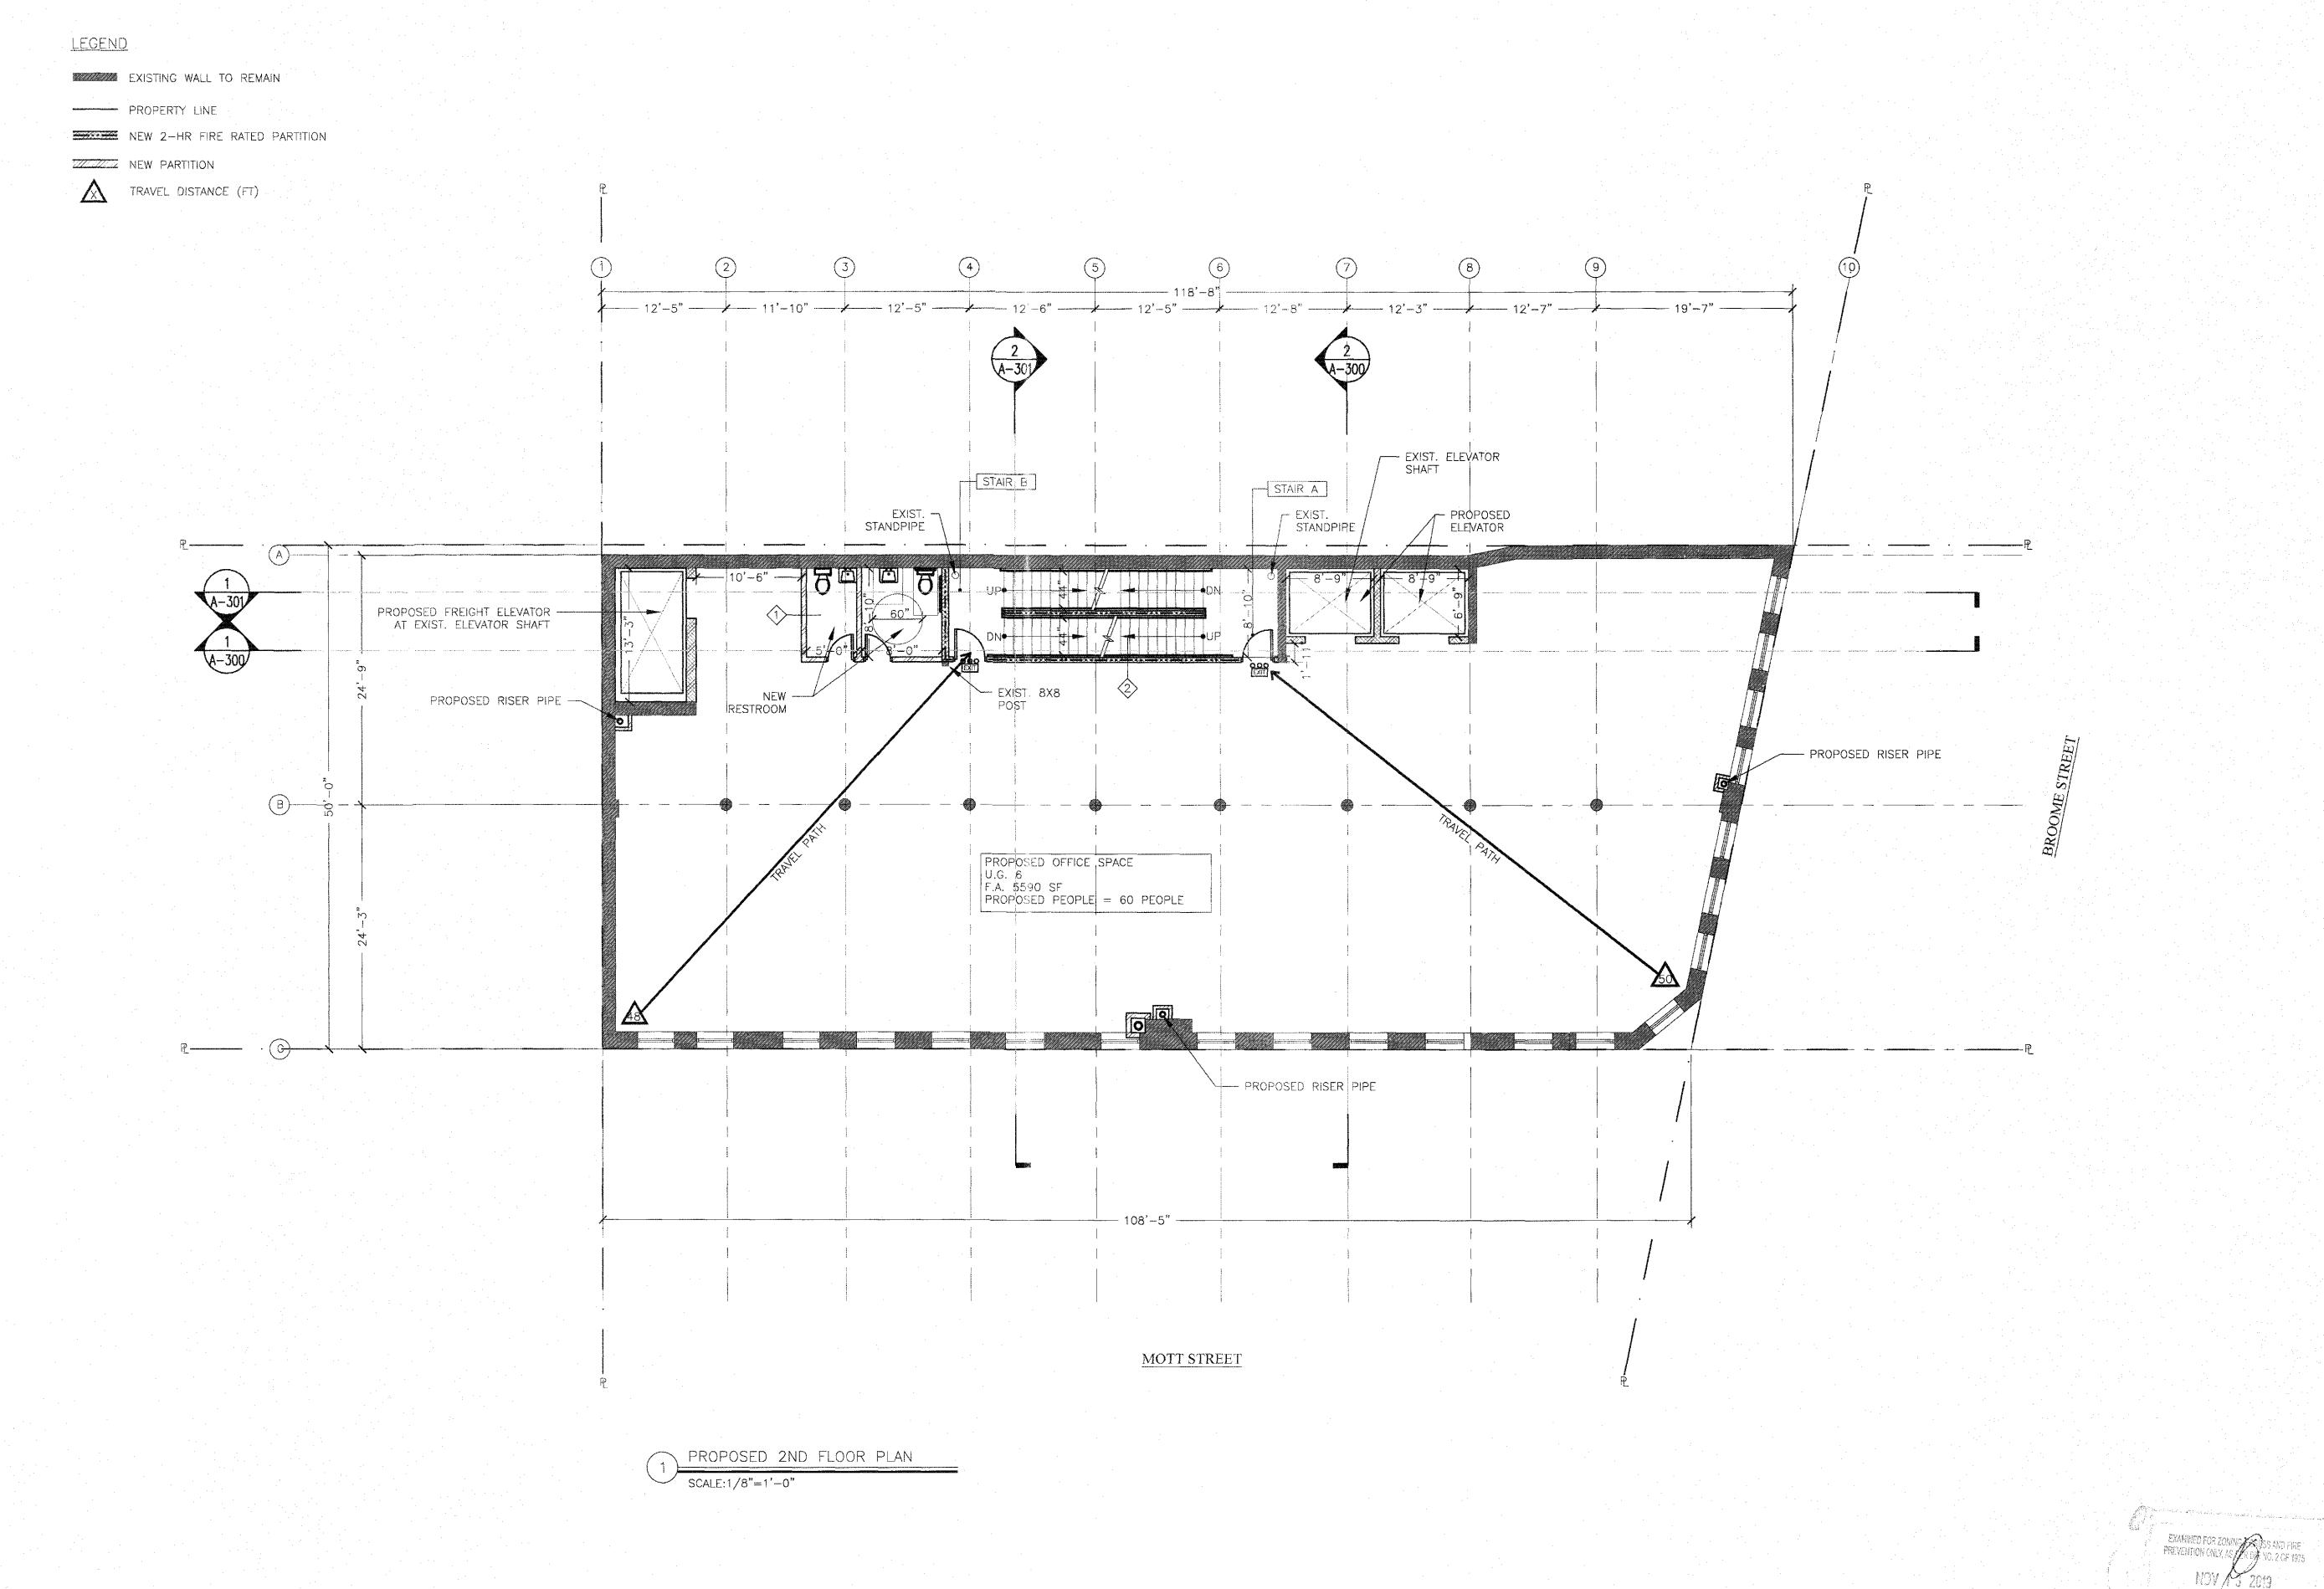
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DEPT BLDGS Job No. 123819305 Scan Code ESHS6549457

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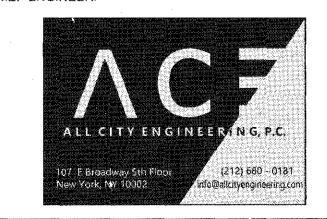
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DESIGN ENGINEER:



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REV#:	DATE	DESCRIPTION:

PROPOSED 2ND FLOOR PLAN

PROJ. #: MW 618

SCALE: AS SHOWN

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DRAWING TITLE:

DRAWING DATE: 06/26/2019

DRAWN BY: JL CHECKED BY: MW
PROFESSIONAL SEAL: OF NEW

ESSIONAL SEAL.

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KENNETH FLADEN, R.A.

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SHEET 19 OF 30

<u>LEGEND</u>

EXISTING WALL TO REMAIN

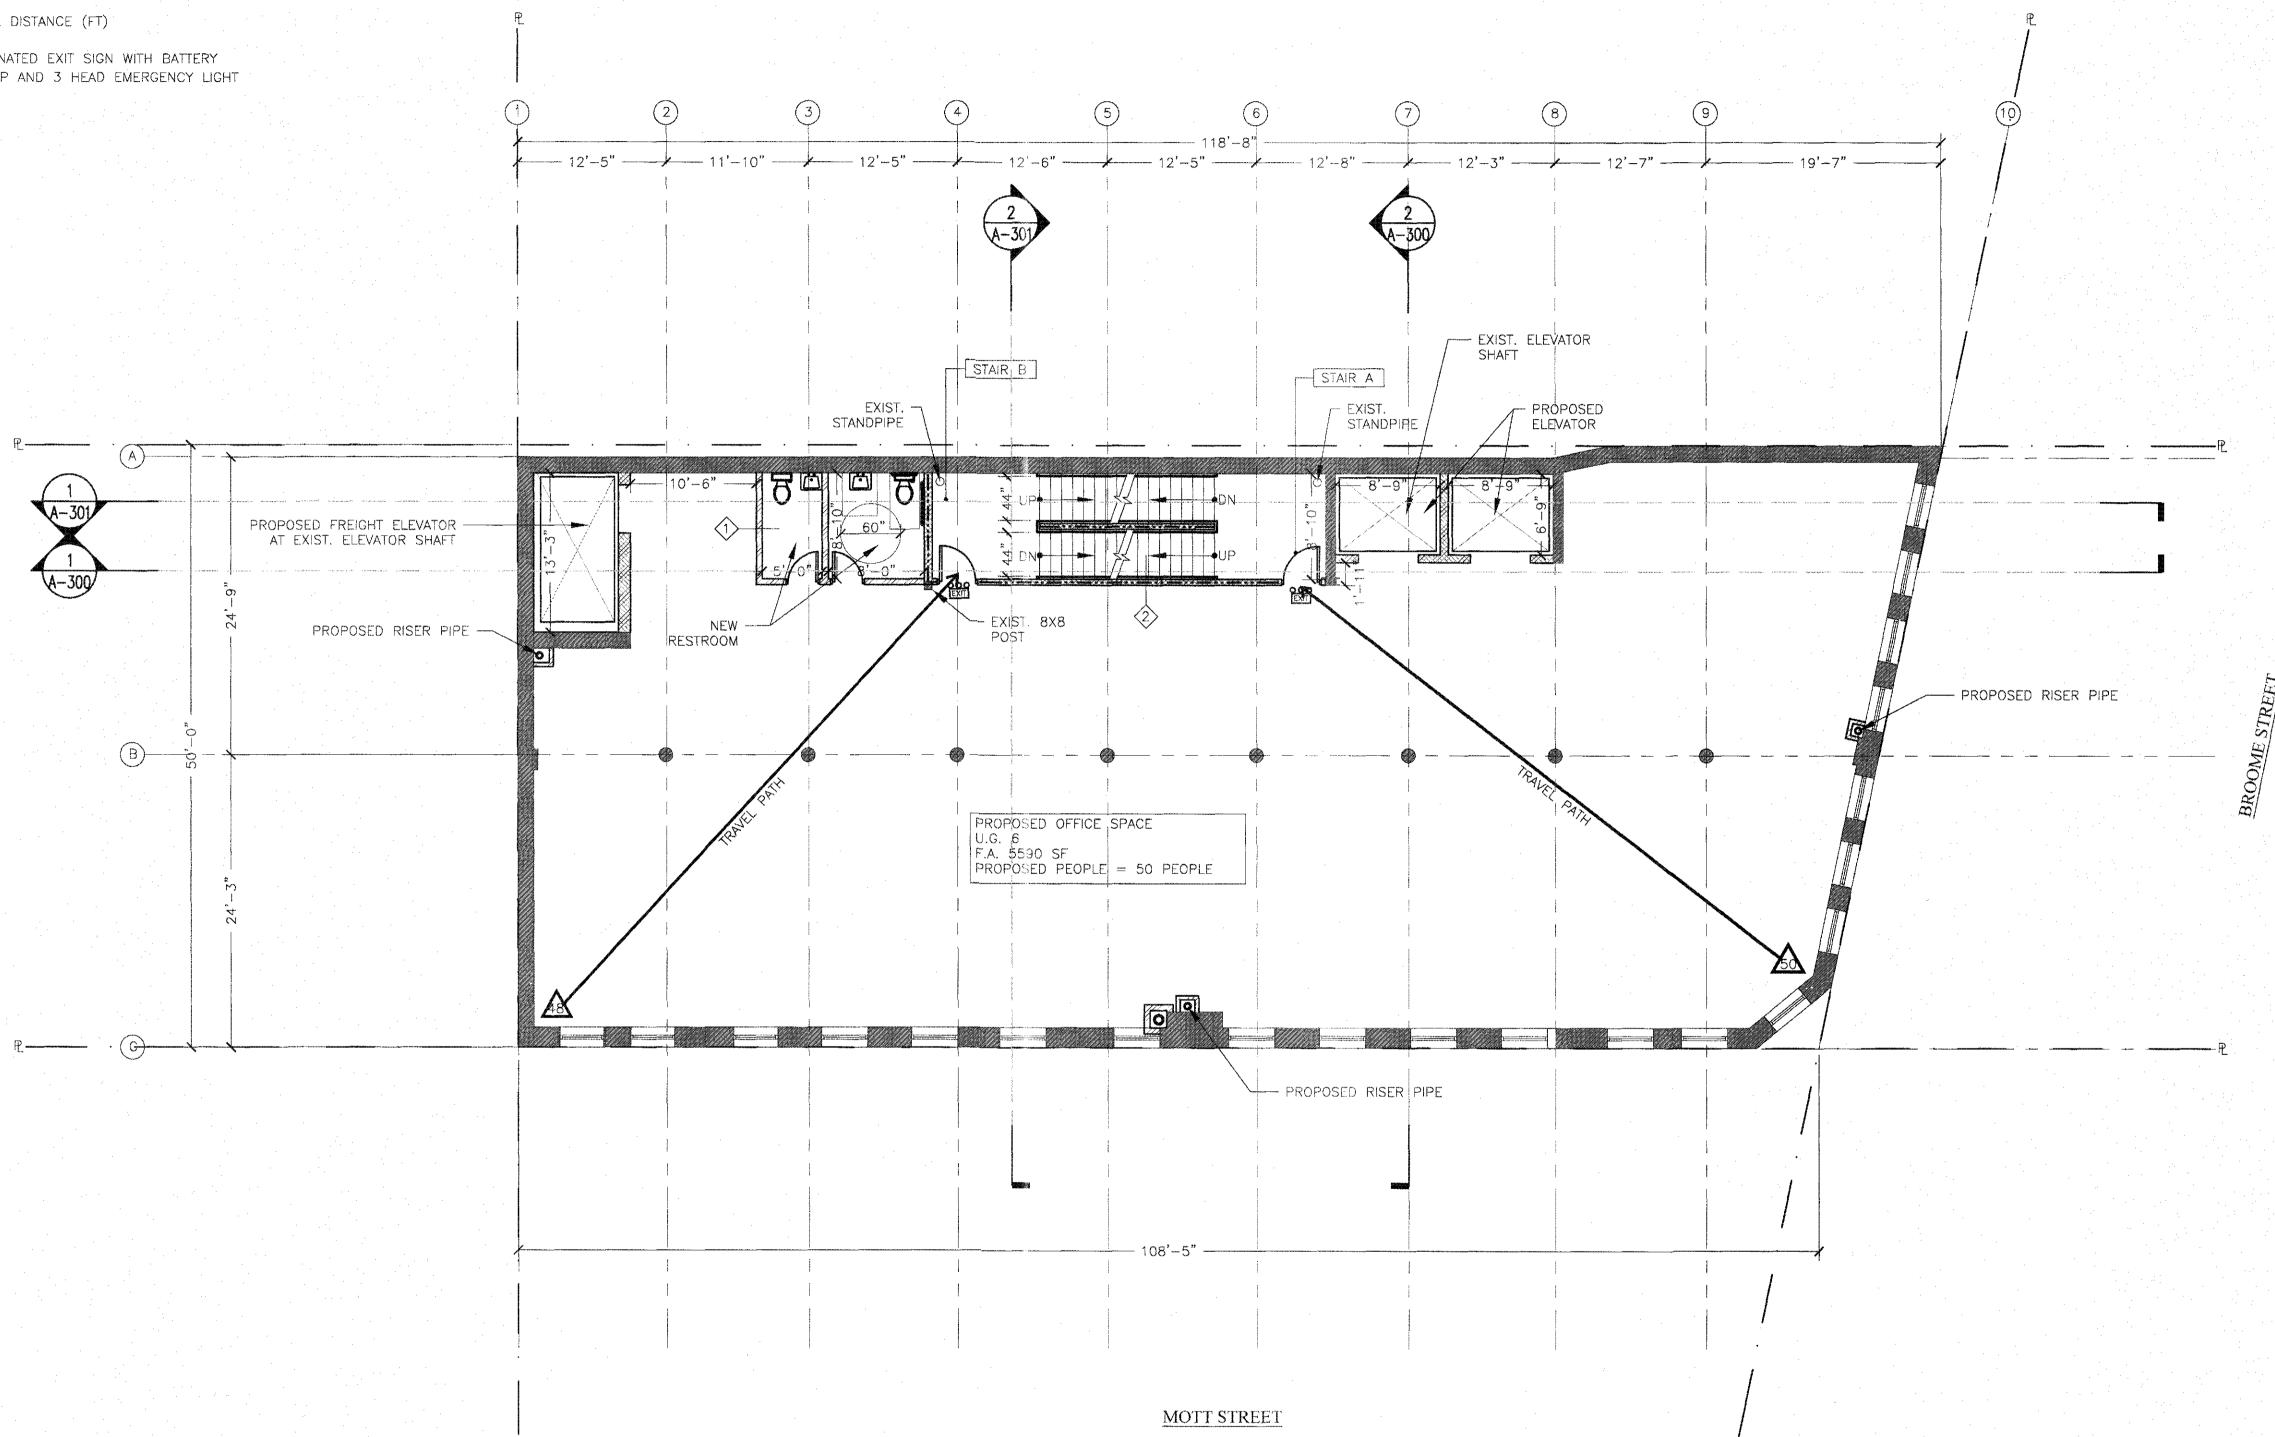
PROPERTY LINE

NEW 2-HR FIRE RATED PARTITION

NEW PARTITION

TRAVEL DISTANCE (FT)

EXIT BACKUP AND 3 HEAD EMERGENCY LIGHT



PROPOSED 3RD FLOOR PLAN

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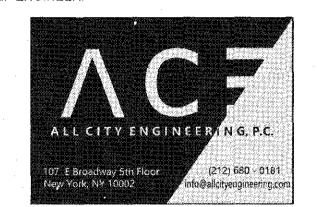
PROJECT NAME:

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REV#: DATE DESCRIPTION:

DRAWING TITLE:

PROPOSED 3RD FLOOR PLAN

PROJ. #: MW 618

SCALE: AS SHOWN

EXAMINED FOR 2017 GLEGRESS AND FIRE PREVENTION ONLY AS PUR DIR NO. 2 OF 1975

NOVY 3 2019

DRAWING DATE: 06/26/2019

DRAWN BY: JL

PROFESSIONAL SEAL:

CHECKED BY: MW

DWG.# A-104.00

DOB BARCODE

DEPT BLDGS Job No. 123819305
Scan Code ESHS8824883

SHEET 20 OF 30

KENNETH FLADEN, R.A.

LEGEND EXISTING WALL TO REMAIN ----- PROPERTY LINE NEW 2-HR FIRE RATED PARTITION TRAVEL DISTANCE (FT)

EXIST. ELEVATOR STAIR; B STAIR A F EXIST. STANDPIRE, EXIST. -STANDPIPE – PRÓPOSED ELEVATOR PROPOSED FREIGHT ELEVATOR -AT EXIST. ELEVATOR SHAFT NEW -PROPOSED RISER PIPE -- PROPOSED RISER PIPE B — PROPOSED OFFICE SPACE U.G. 6 F.A. 5590 SF PROPOSED PEOPLE = 60 PEOPLE P C — PROPOSED RISER PIPE MOTT STREET

PROPOSED 2ND FLOOR PLAN

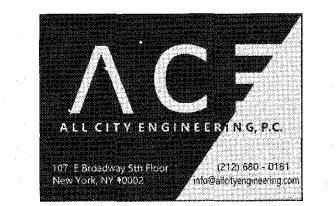
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	REV#:	DATE	DESCRIPTION:	
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	DRAWIN	IG TITLE:		

PROPOSED 4TH FLOOR PLAN

PROJ. #:	MW 618
 SCALE:	AS SHOWN
 DRAWING D	ATE: 06/26/2019

CHECKED BY: MW DRAWN BY: JL

PROFESSIONAL SEAL:

DWG.#

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SHEET 21 OF 30

<u>LEGEND</u> EXISTING WALL TO REMAIN PROPERTY LINE NEW 2-HR FIRE RATED PARTITION NEW PARTITION TRAVEL DISTANCE (FT) EXIT BACKUP AND 3 HEAD EMERGENCY LIGHT EXIST. ELEVATOR
SHAFT STAIR B STAIR A EXIST. — EXIST. STANDPIRE PRÓPOSED ELEVATOR PROPOSED FREIGHT ELEVATOR — AT EXIST. ELEVATOR SHAFT - EXIST. 8X8 PROPOSED RISER PIPE -PROPOSED RISER PIPE (B) PROPOSED OFFICE SPACE U.G. 6 F.A. 5590 SF PROPOSED PEOPLE = 50 PEOPLE

- PROPOSED RISER PIPE

MOTT STREET

PROPOSED 5TH FLOOR PLAN SCALE:1/8"=1'-0"

P . C

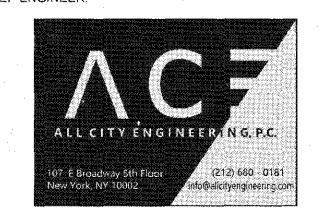
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DRAWING TITLE:

PROPOSED 5TH FLOOR PLAN

PROJ. #: MW 618

SCALE: AS SHOWN

DRAWING DATE: 06/26/2019

CHECKED BY: MW DRAWN BY: JL

PROFESSIONAL SEAL:

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DOB BARCODE



SHEET 22 OF 30

LEGEND

EXISTING WALL TO REMAIN

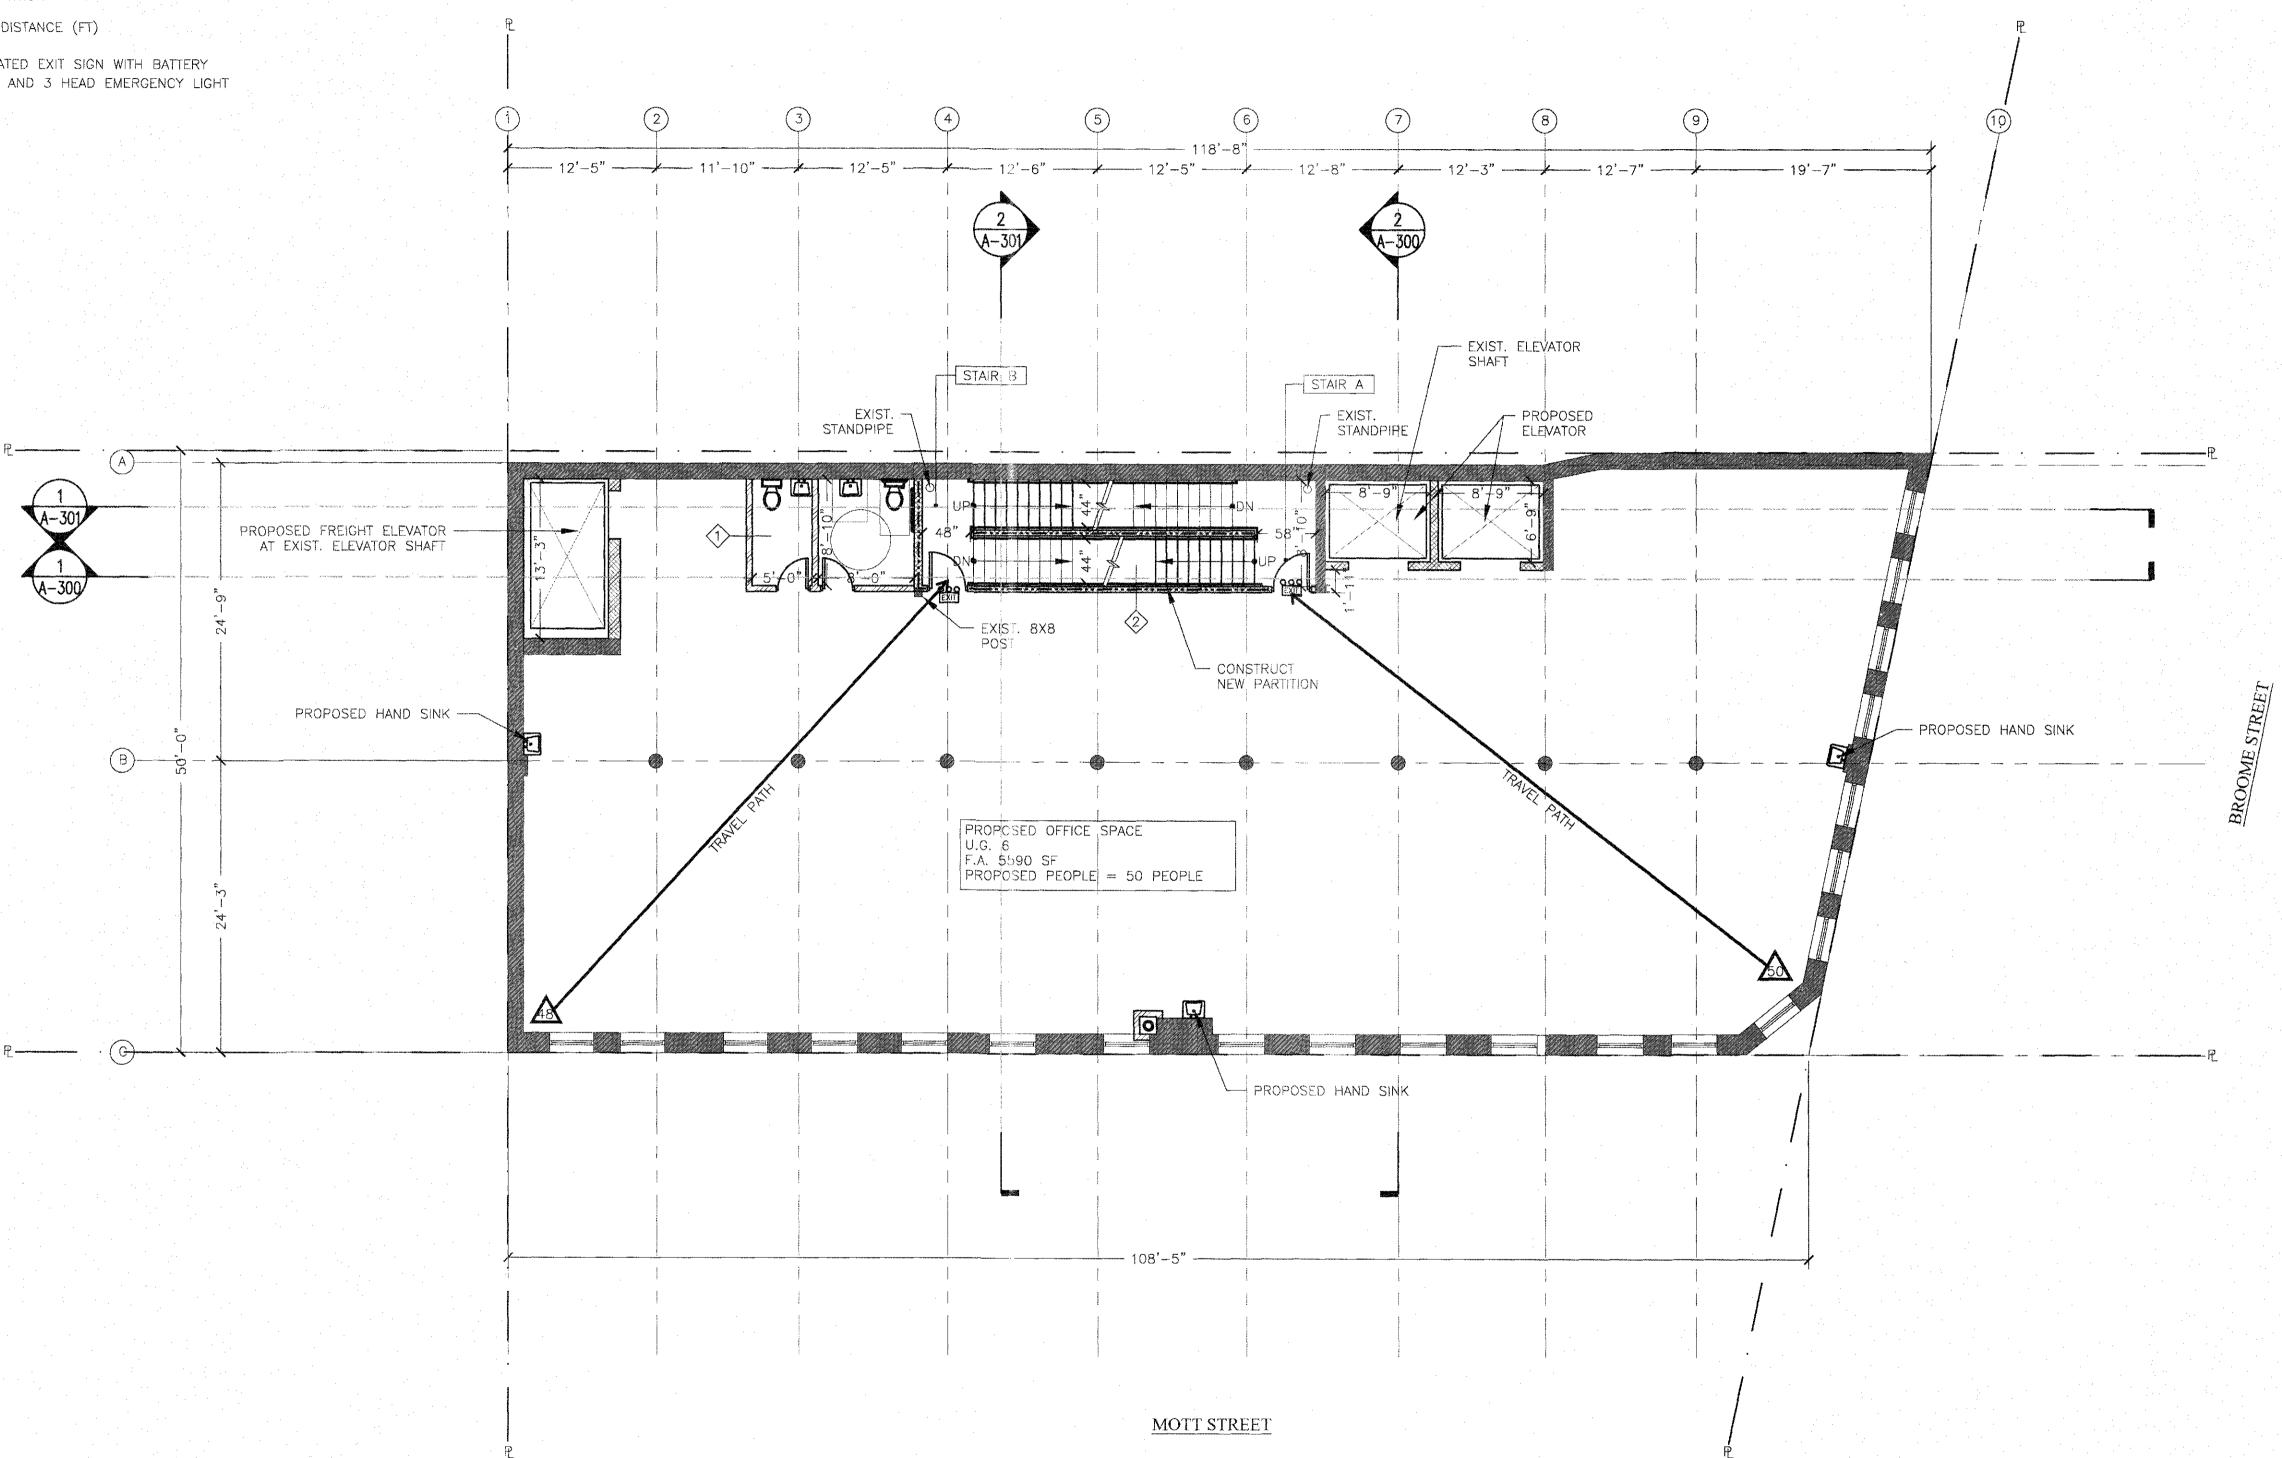
PROPERTY LINE

NEW 2-HR FIRE RATED PARTITION

NEW PARTITION

TRAVEL DISTANCE (FT)

illuminated exit sign with battery backup and 3 head emergency light



PROPOSED 6TH FLOOR PLAN SCALE:1/8"=1'-0"

NOTE: THERE IS NO HVAC, PLUMBING AND SPRINKLER WORK SHOWN ON THIS PAGE. FOR HVAC, PLUMBING AND SPRINKLER PROPOSED WORK, SEE MEP DWG.

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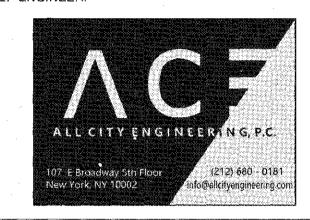
178 MOTT STREET NEW YORK, NY 10012 OFFICE CONVERSION

DESIGN ENGINEER:

PROJECT NAME:



MEP ENGINEER:

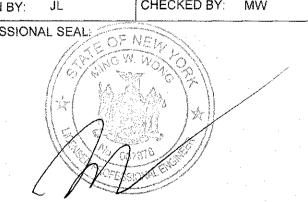


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PROPOSED 6TH FLOOR PLAN

	DRAWN BY	/: JL	CHECKED BY:	M۱
• •	DRAWING	DATE: 06/26/201	9	
	SCALE:	AS SHOWN		
	PROJ. #:	MW 618		



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DOB BARCODE

DWG.#



SHEET 23 OF 30

<u>LEGEND</u>

EXISTING WALL TO REMAIN

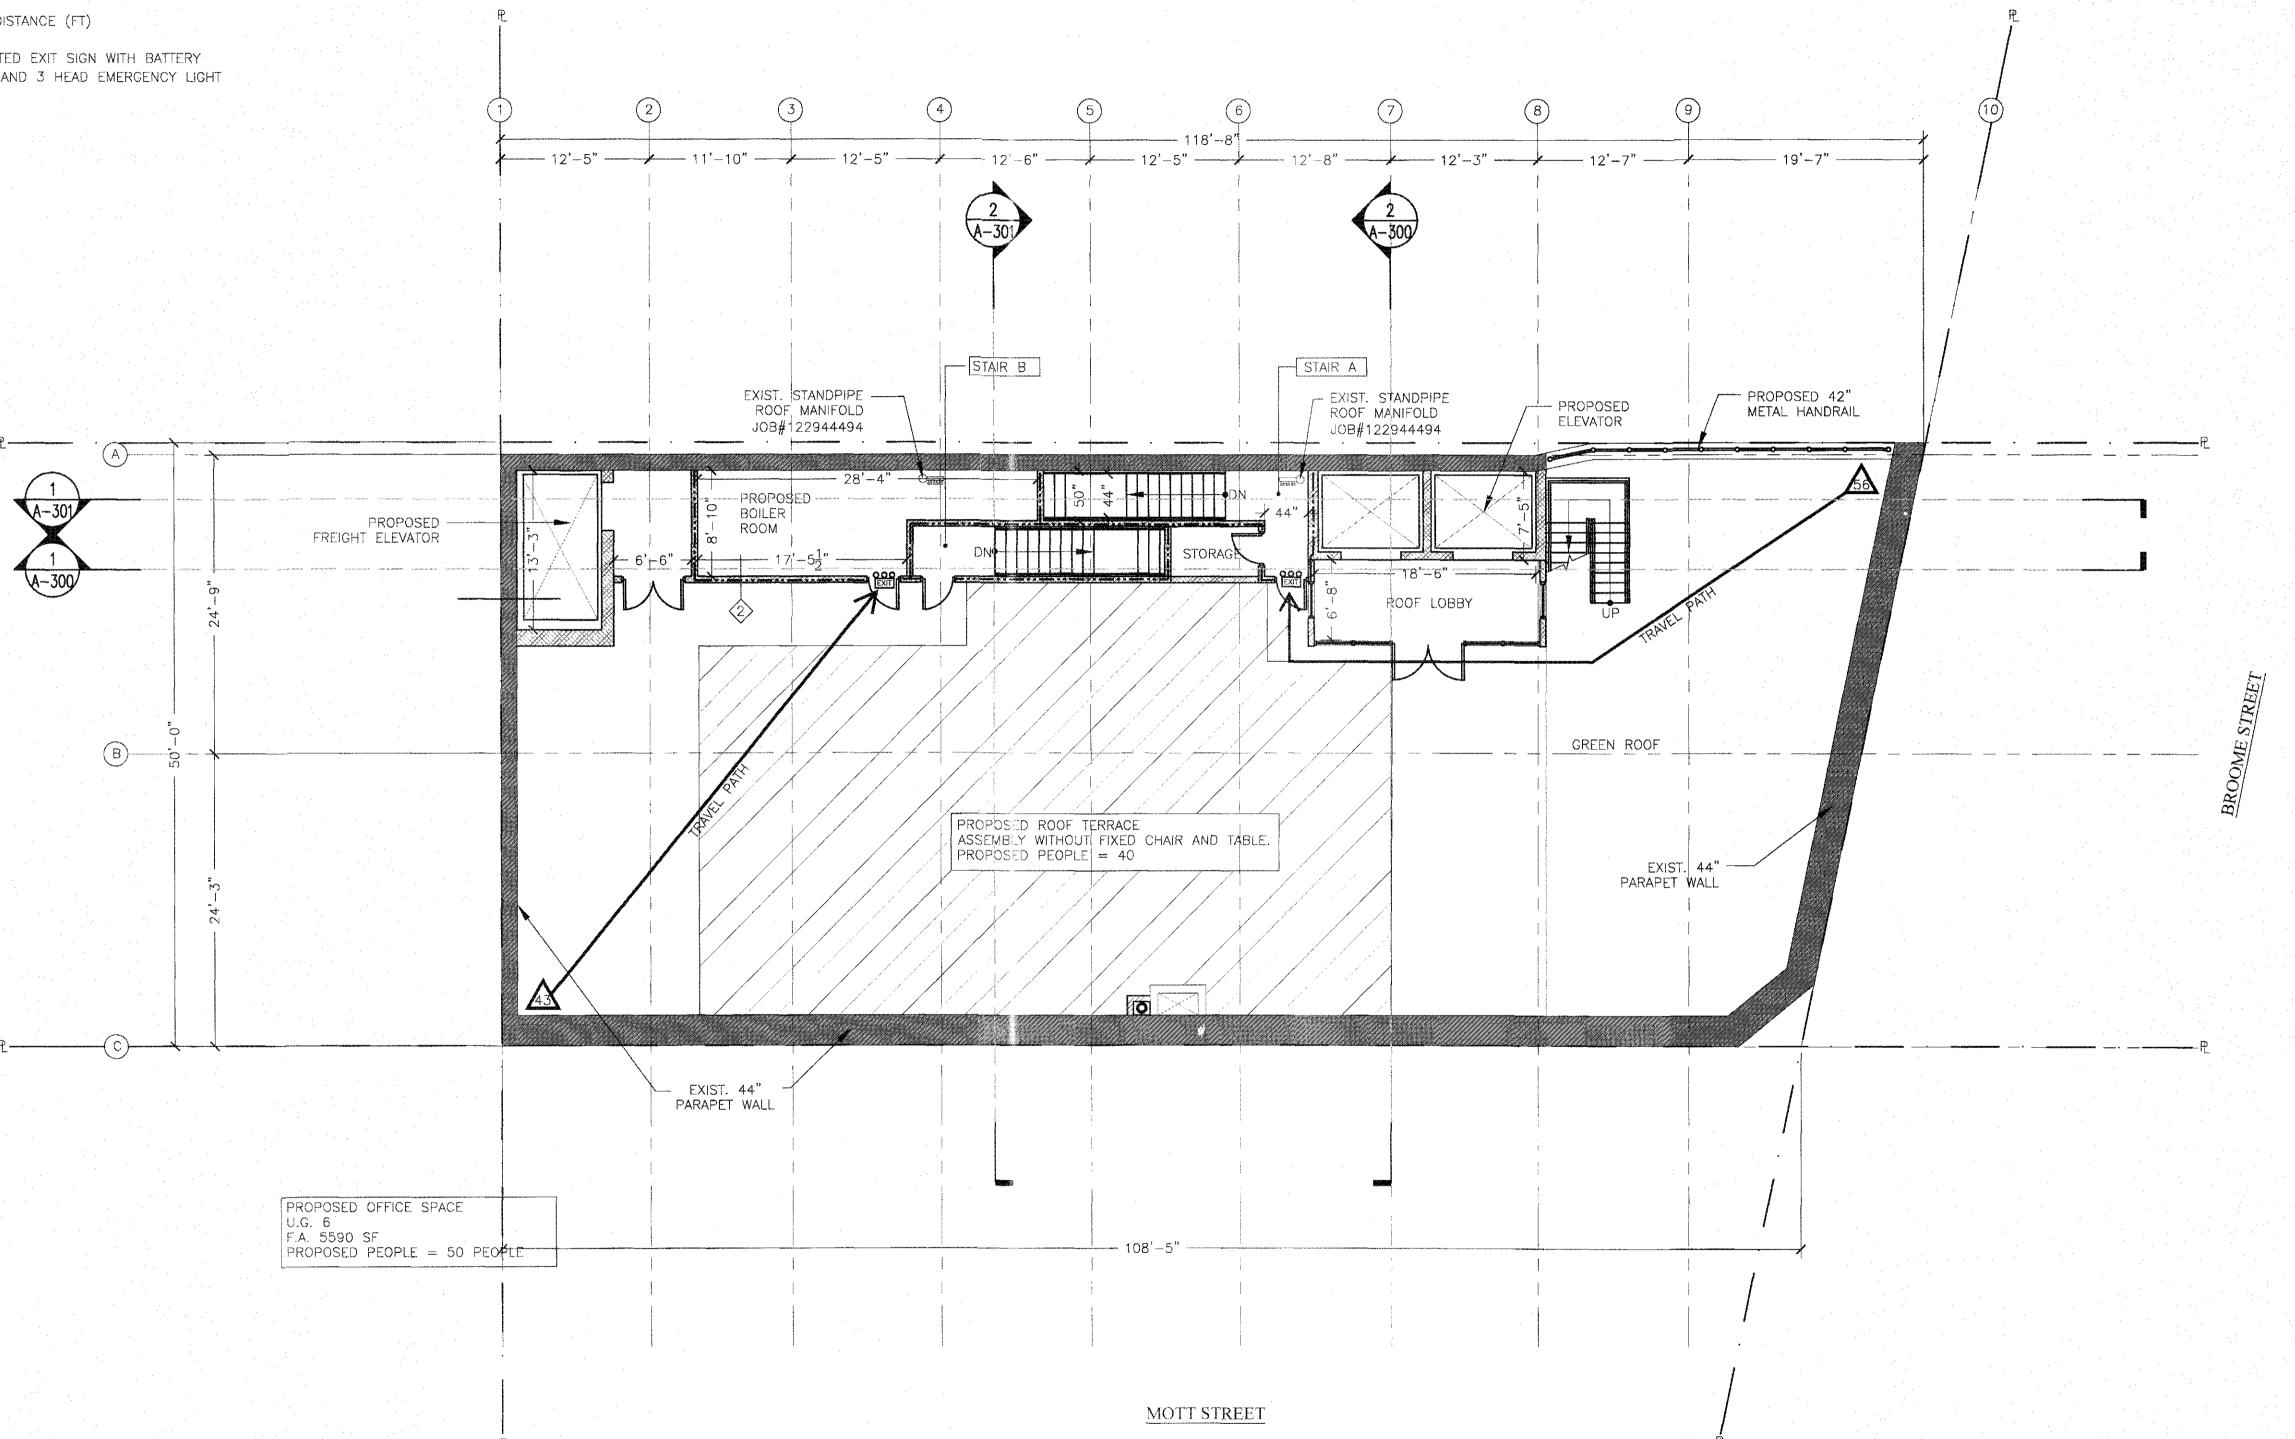
PROPERTY LINE

NEW 2-HR FIRE RATED PARTITION

ZZZZZZZ NEW PARTITION

TRAVEL DISTANCE (FT)

EXIT BACKUP AND 3 HEAD EMERGENCY LIGHT



PROPOSED ROOF PLAN SCALE:1/8"=1'-0"

THERE IS NO HVAC, PLUMBING AND SPRINKLER WORK SHOWN ON THIS PAGE. FOR HVAC, PLUMBING AND SPRINKLER PROPOSED WORK, SEE MEP DWG.

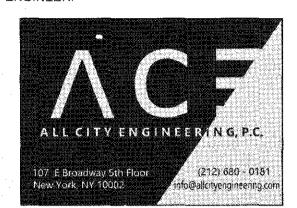
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PROPOSED ROOF PLAN

PROJ. #: MW 618 SCALE: AS SHOWN DRAWING DATE: 06/26/2019 CHECKED BY: MW DRAWN BY: JL

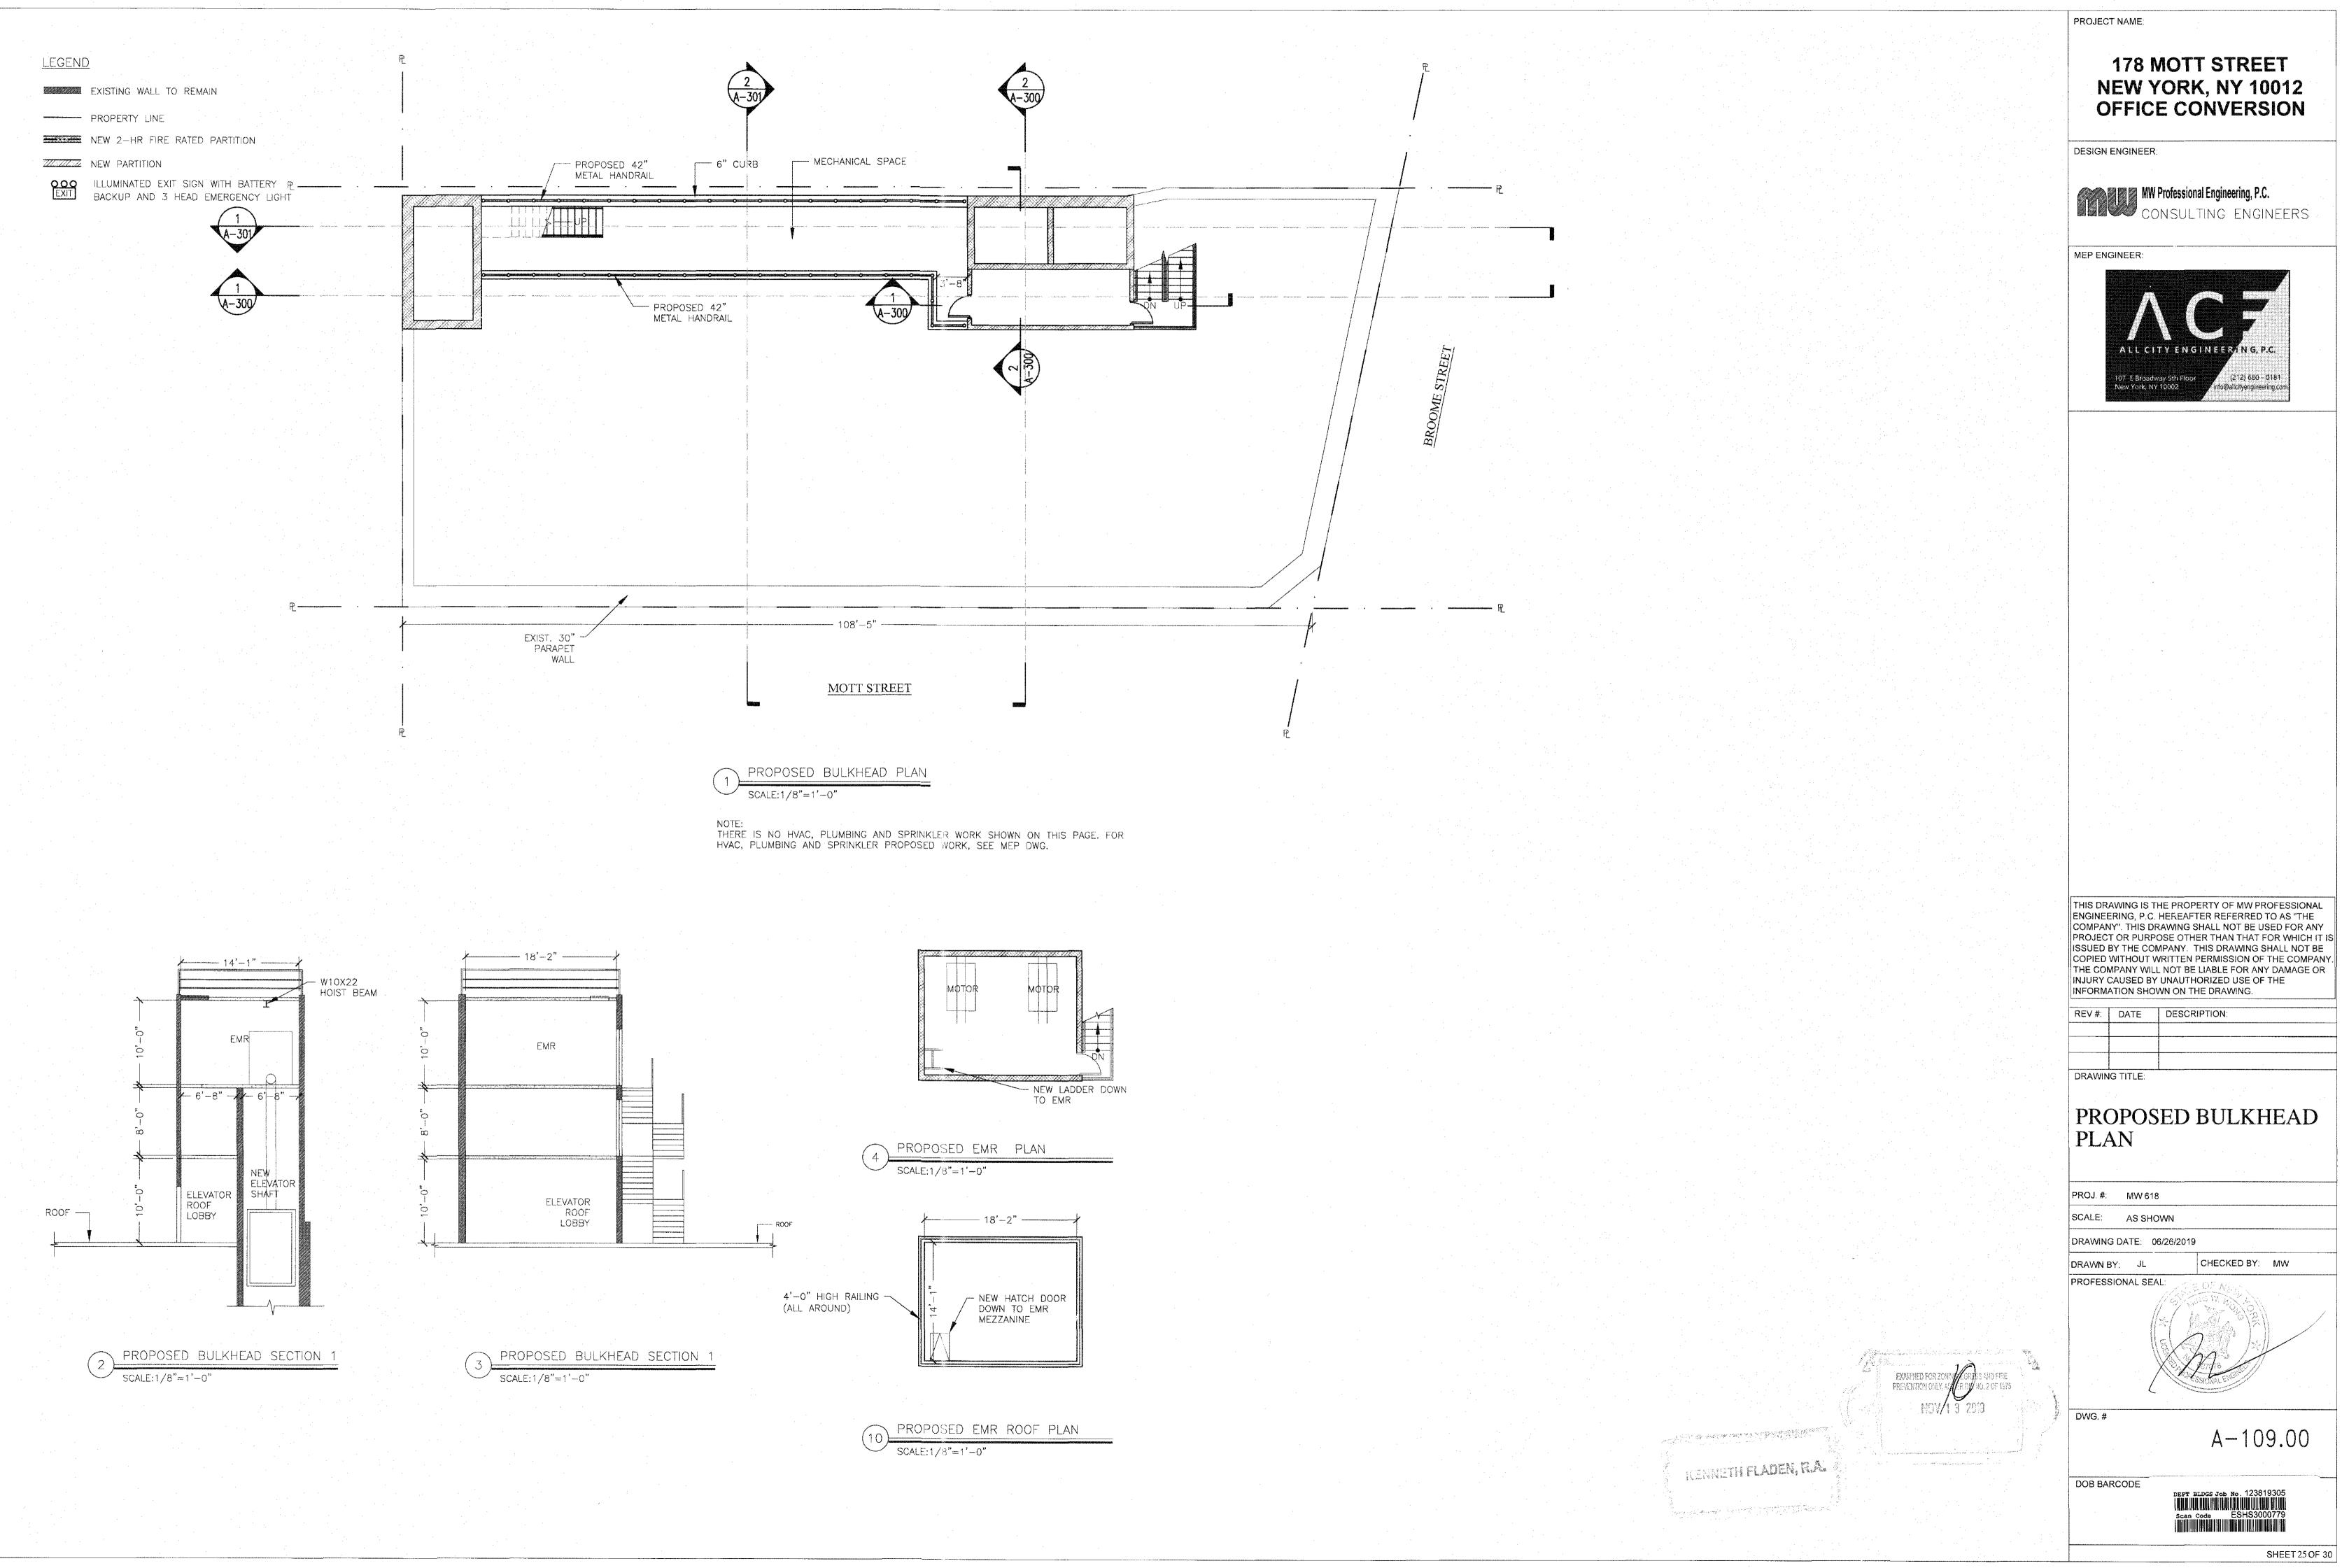
PROFESSIONAL SEAL: pwg.#

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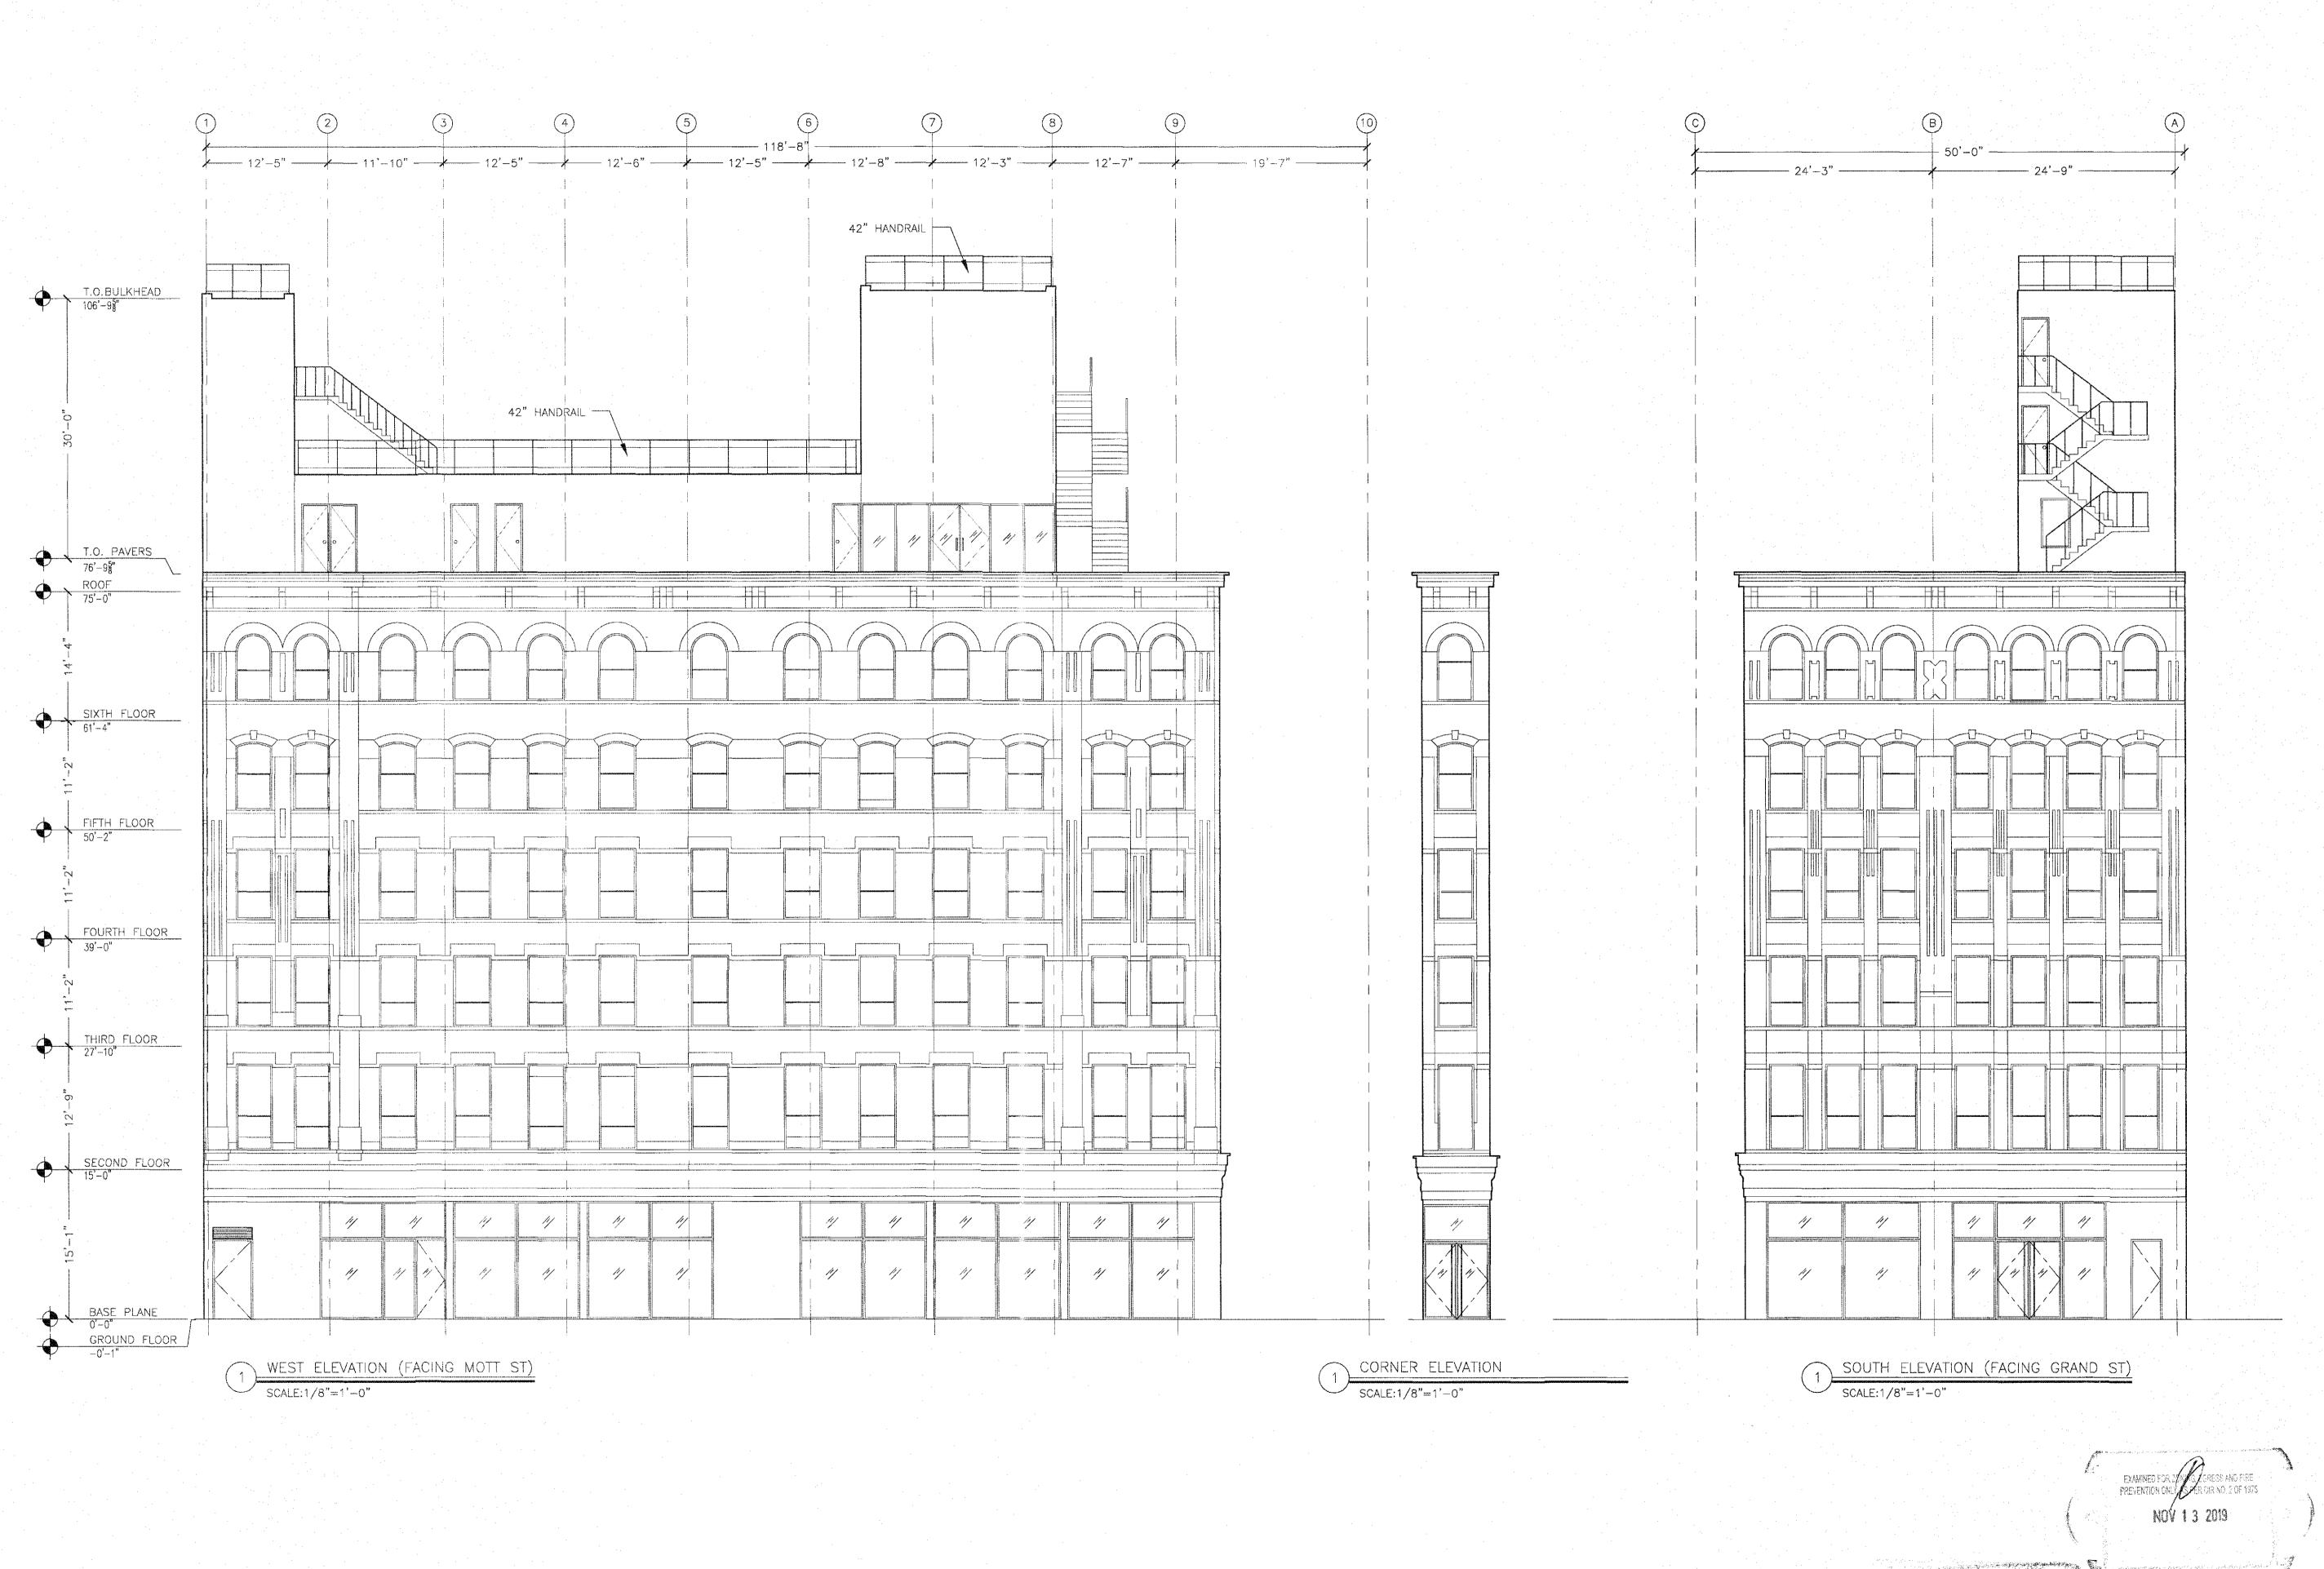
DEPT BLDGS Job No. 123819305
Scan Code ESHS1323401

SHEET 24 OF 30



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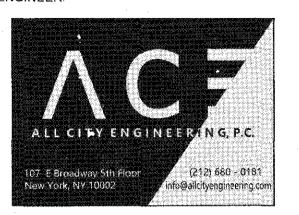
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PROJ. #: MW 618

SCALE: AS SHOWN

DRAWING DATE: 06/26/2019

CHECKED BY: MW DRAWN BY: JL

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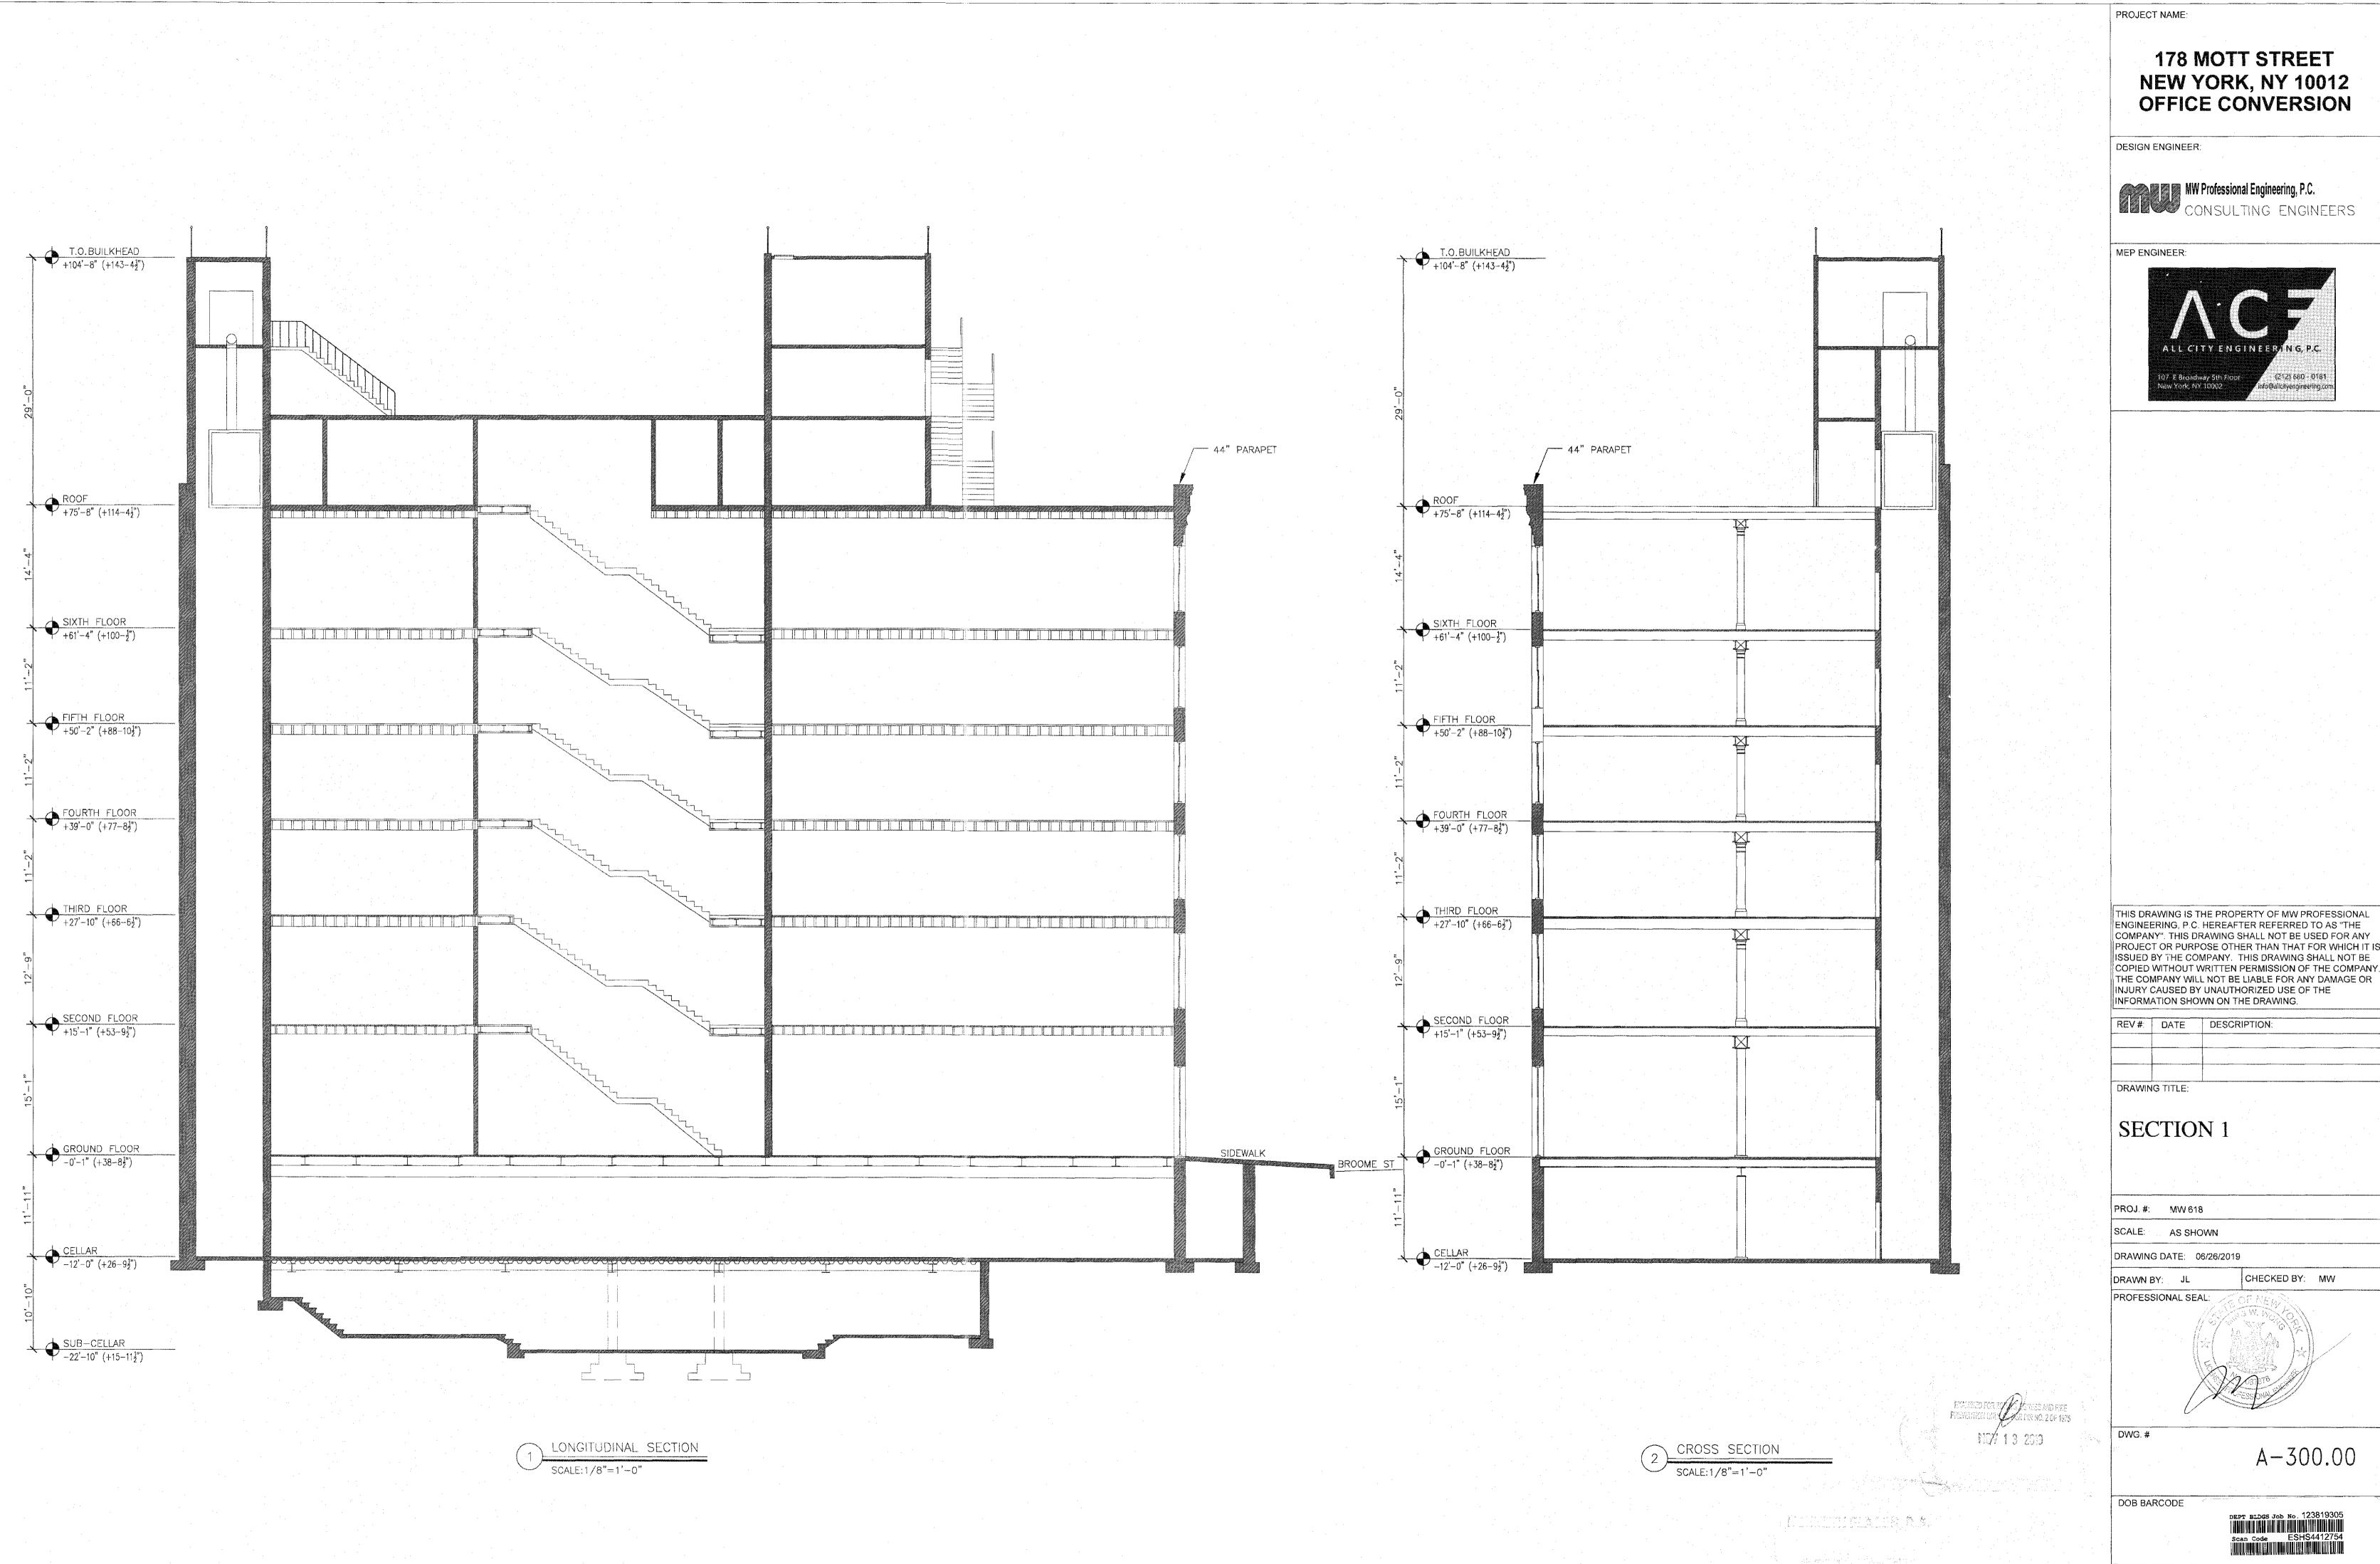
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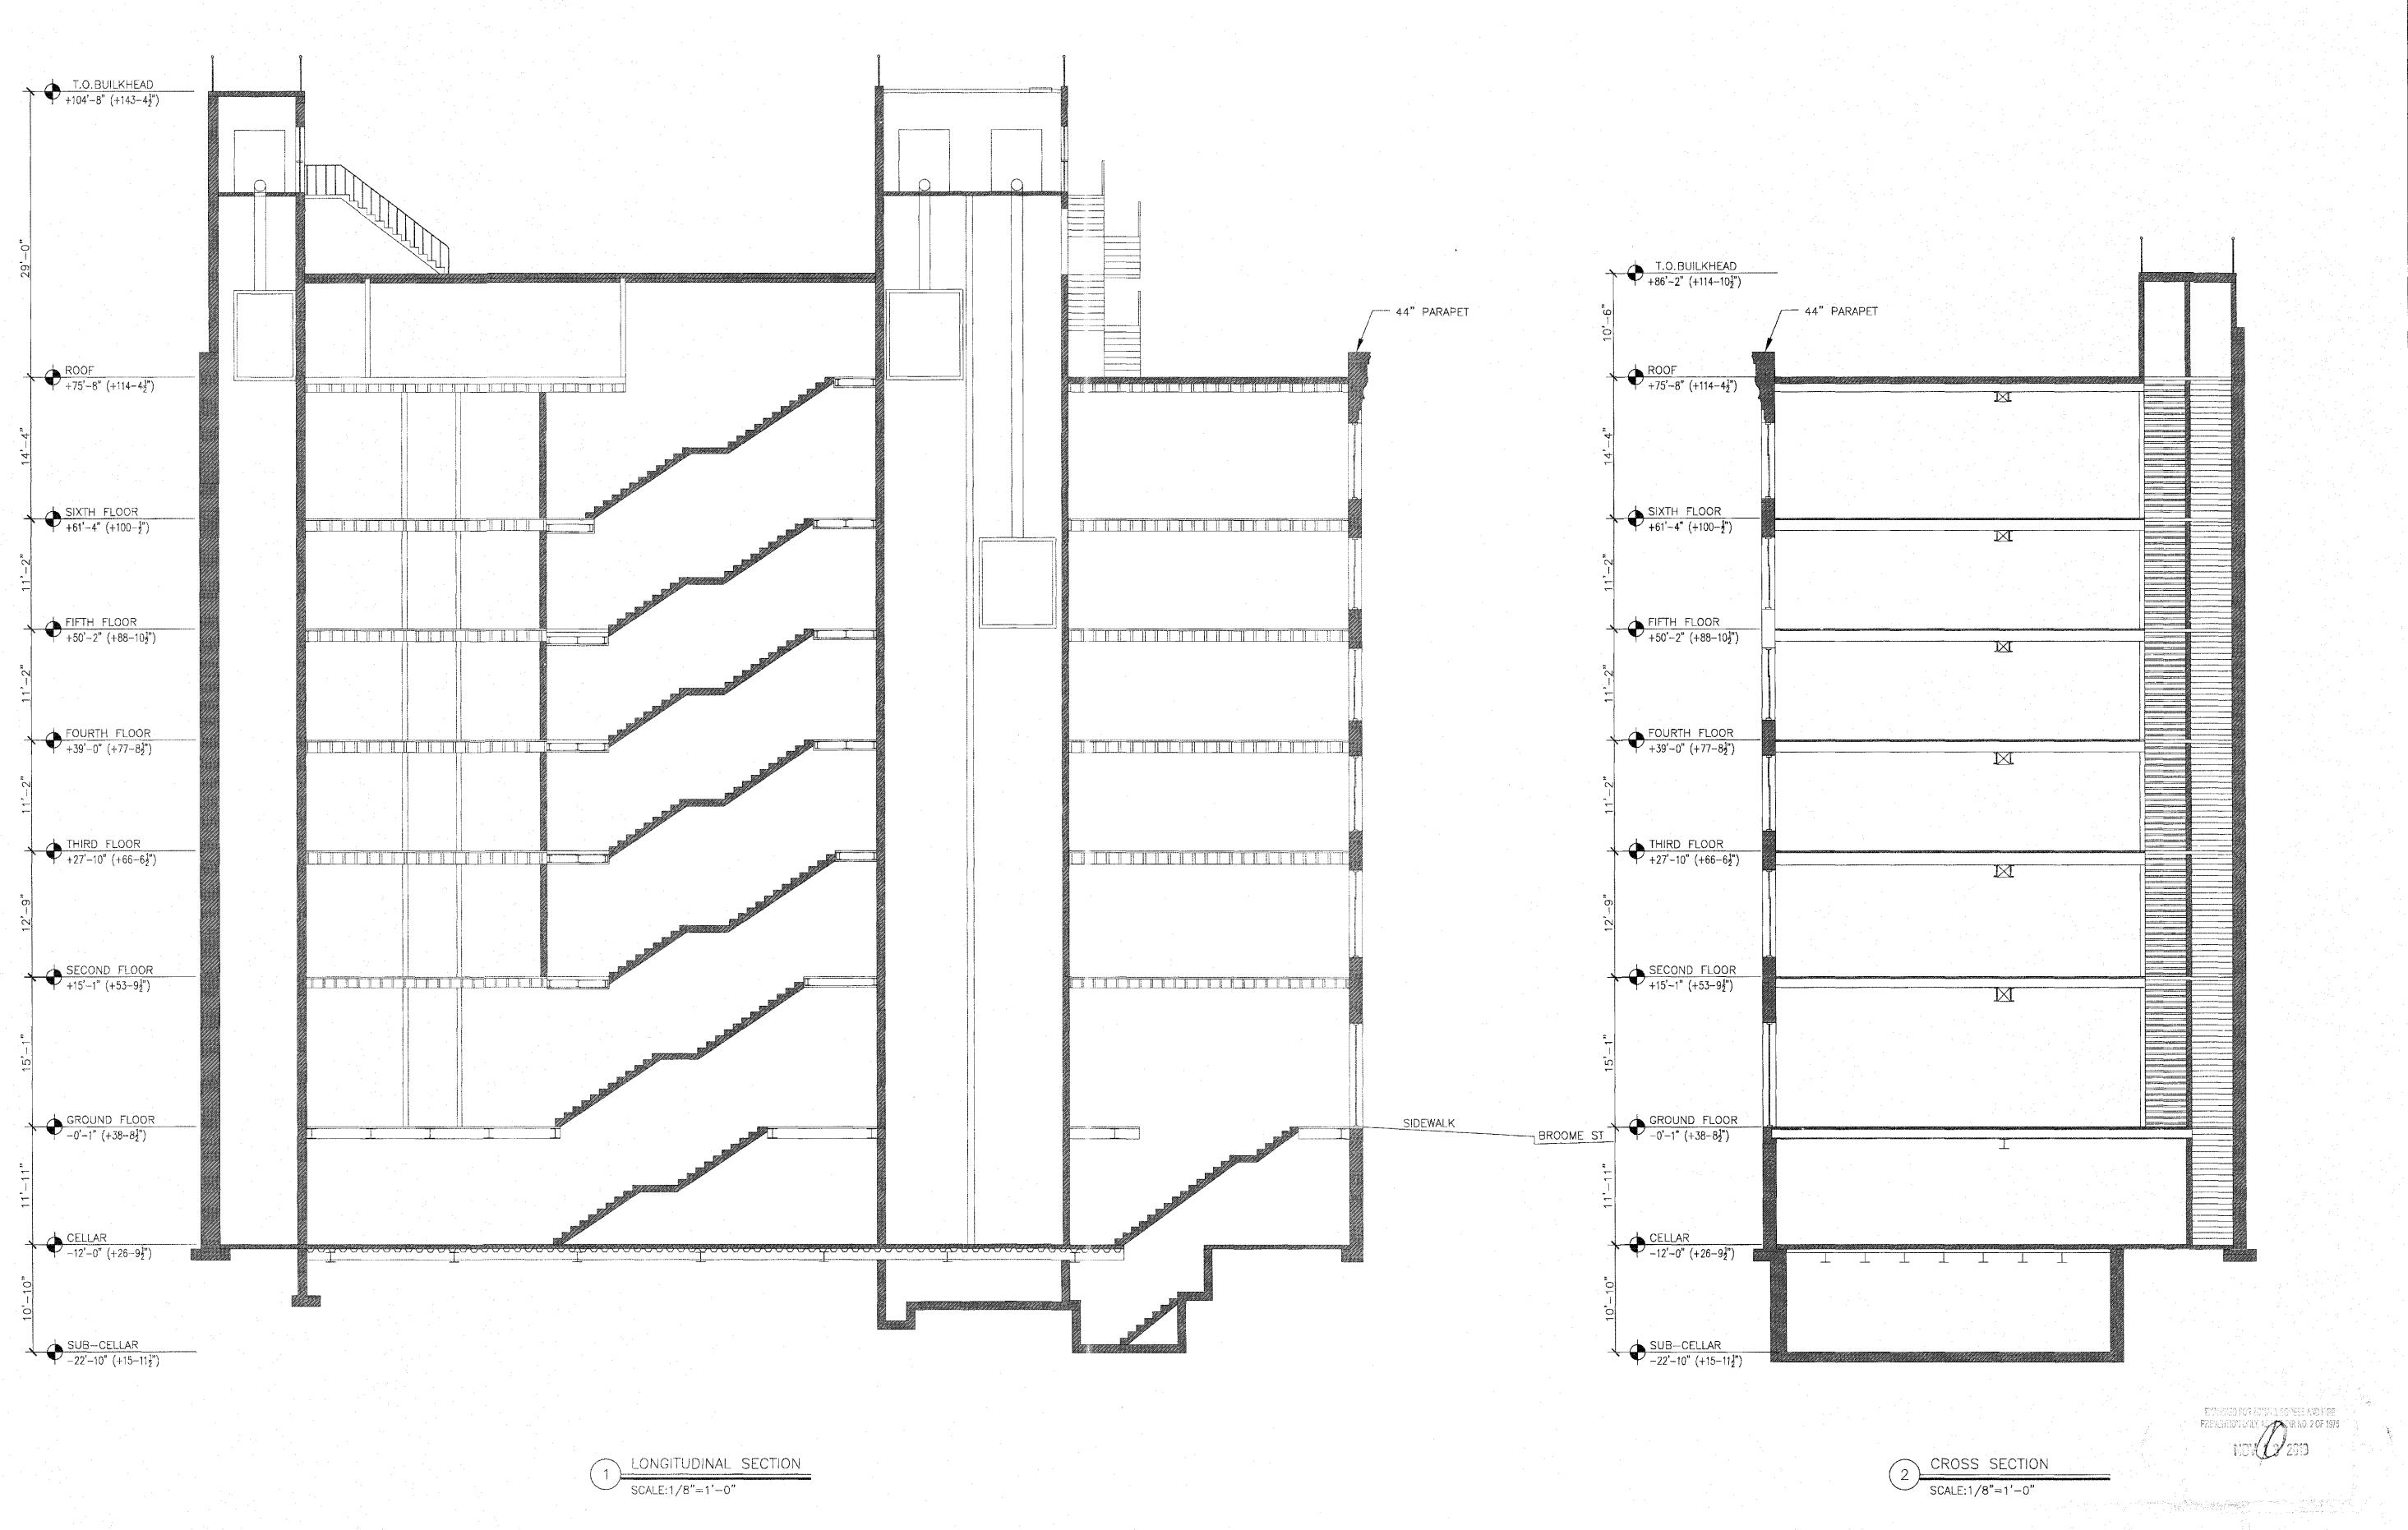
KENNETH FLADEN, RA.

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SHEET 27 OF 30



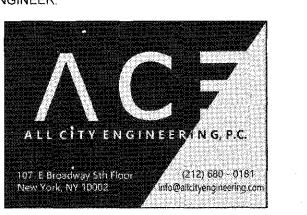
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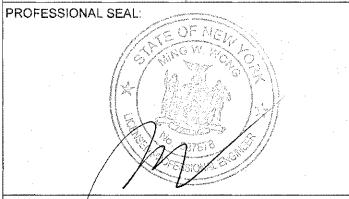
DRAWING TITLE:

SECTION 2

PROJ. #: MW 618 SCALE: AS SHOWN

DRAWING DATE: 06/26/2019

CHECKED BY: MW DRAWN BY: JL



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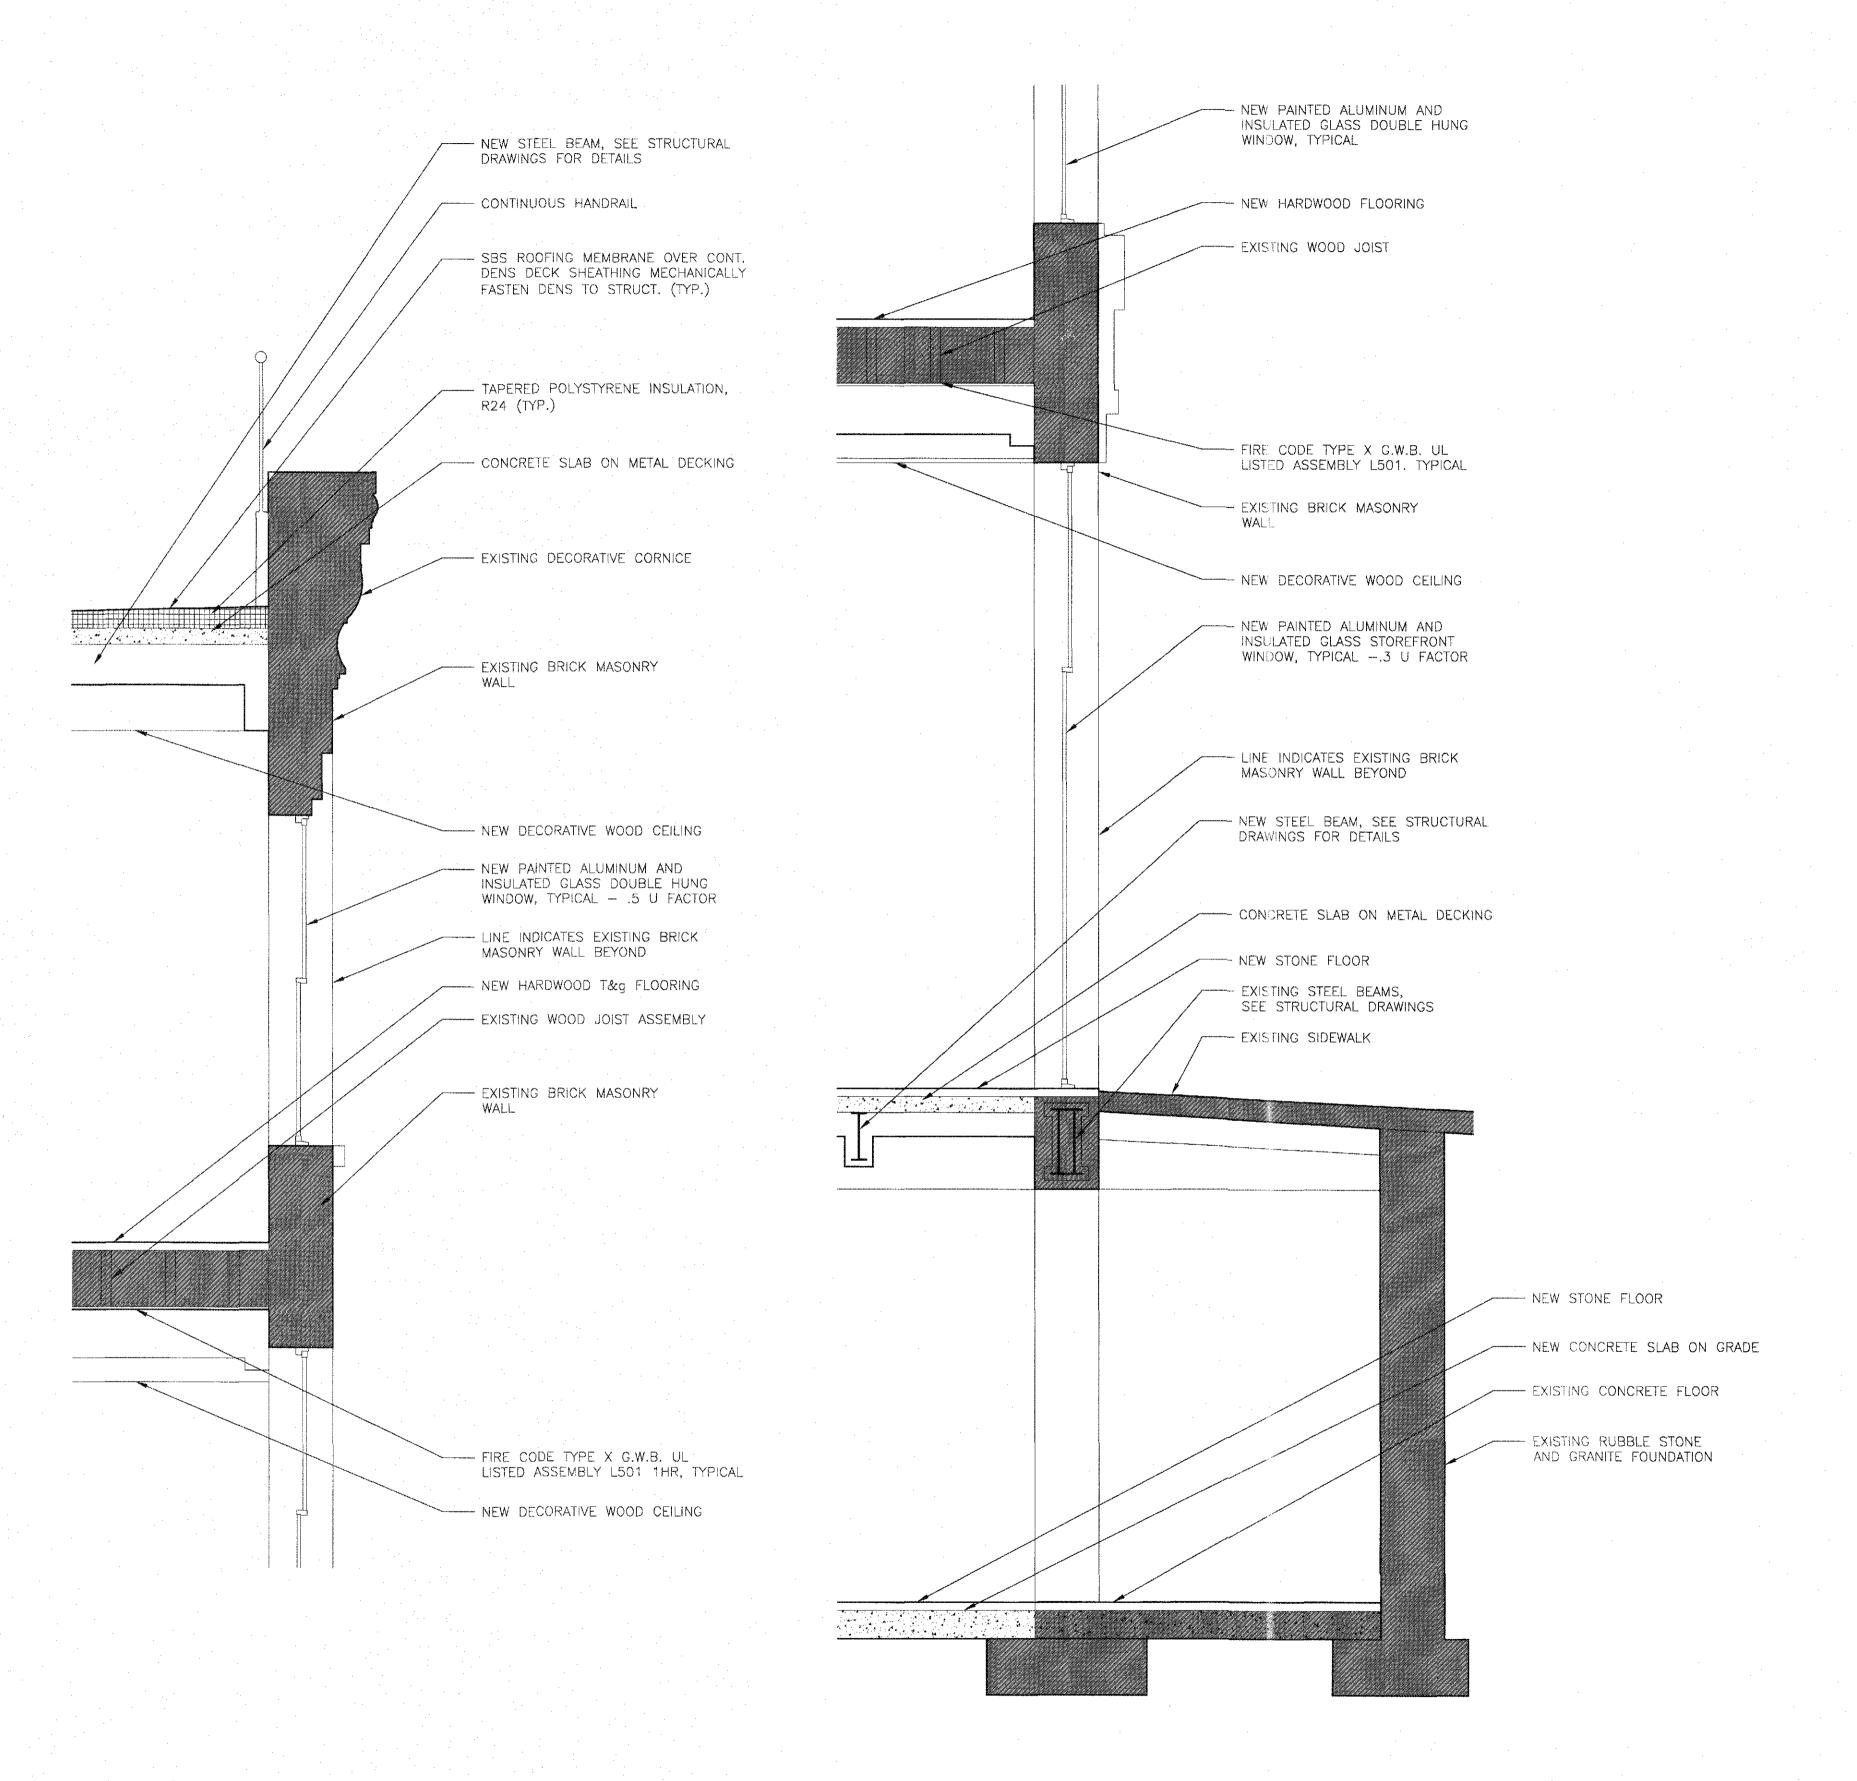
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DOB BARCODE

DEPT BLDGS Job No. 123819305
Scan Code ESHS9301162

SHEET 28 OF 30



WALL SECTION B

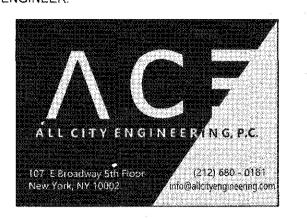
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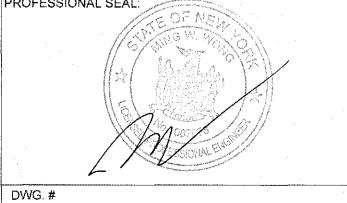
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DRAWING TITLE:

PROJ. #: MW 618

WALL SECTIONS TYPICAL CONDITIONS

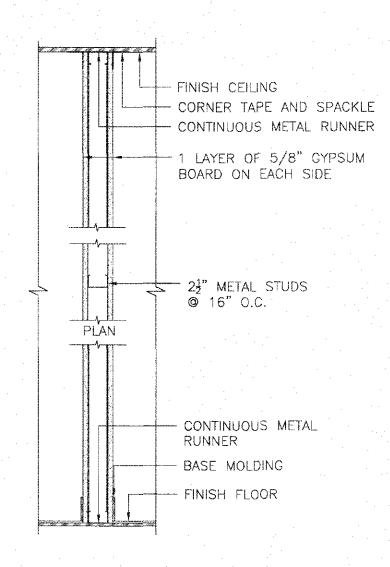
SCALE: AS SHOWN		
DRAWING DATE: 06/26/2019		
DRAWN BY: JL	CHECKED BY:	M
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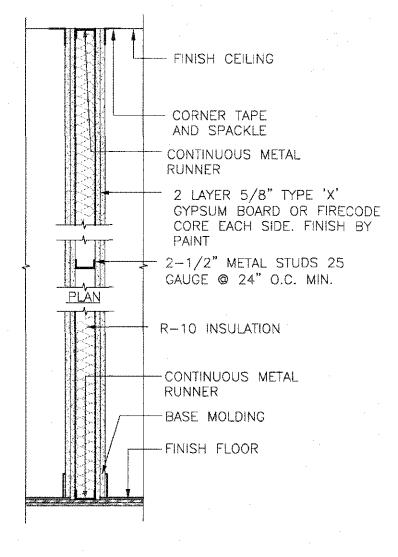
A - 302.00



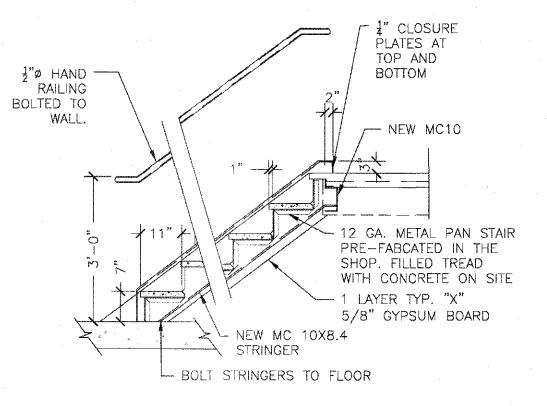
SHEET 29 OF 30



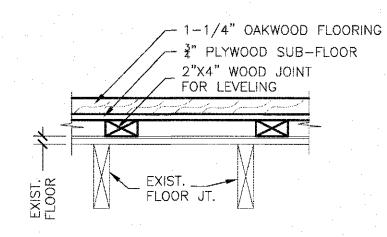
TYPE 1 - REGULAR FULL HEIGHT PARTITION SCALE: N.T.S.



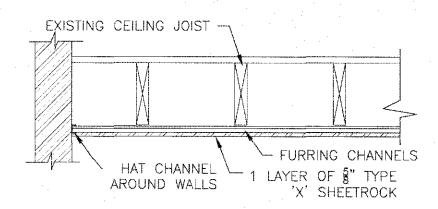
2-HR RATED PARTITION DETAIL



TYPICAL STAIR DETAIL

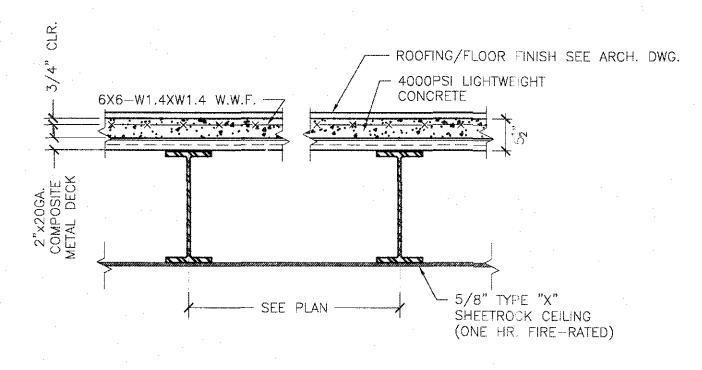


TYPICAL FLOOR DETAIL SCALE:1/8"=1'-0"



5 TYPICAL CEILING DETAIL - 1HR

NOTE: NEW CEILING BEING INSTALLED WILL COMPLY WITH RS5 OF NYC BC 1968.



TYPICAL ROOF CONSTRUCTION DETAIL

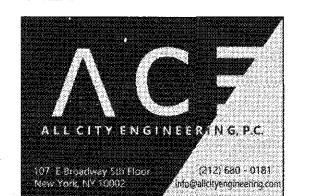
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DETAIL

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DRAWING DATE: 06/26/2019 DRAWN BY: JL CHECKED BY: MW	DRAWING DATE: 06/26/2019 DRAWN BY: JL CHECKED BY: MY	PROJ. #:	MW 618	
DRAWN BY: JL CHECKED BY: MW	DRAWN BY: JL CHECKED BY: MY	SCALE:	AS SHOWN	
		DRAWING D	ATE: 06/26/20	019
PROFESSIONAL SEAL:	PROFESSIONAL SEAL:	DRAWN BY:	JL	CHECKED BY: M
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DOB BARCODE



SHEET 30 OF 30